86 RIVERSIDE DRIVE NEW YORK, NY 10024

PROJECT INFORMATION

PROJECT DESCRIPTION AND SCOPE OF WORK: THIS IS A PERMIT APPLICATION FOR ROOFTOP ADDITION ONLY.

NO CHANGE TO ZONE, USE, OCCUPANCY OR EGRESS

EXISTING USE: RESIDENTIAL (PRIVATE DWELLING) CONSTRUCTION TYPE: CLASS 3: NON-FIREPROOF STRUCTURE

EXISTING # OF EXITS: 86 RIVERSIDE DRIVE NEW YORK CITY, NY, 10024 ZONING DISTRICT: R-10A

BUILDING LEVELS:

BLOCK:

APPLICABLE CODES

ALL WORK SHALL BE IN CONFORMANCE WITH, BUT NOT LIMITED TO THE REQUIREMENTS OF THE FOLLOWING AND ANY OTHER FEDERAL, STATE AND LOCAL CODES, LAWS AND ORDINANCES THAT APPLY: 1938 NEW YORK CITY BUILDING CODE 2011 NEW YORK CITY ELECTRICAL CODI

2014 NEW YORK CITY PLUMBING CODE 2014 NEW YORK CITY MECHANICAL CODI 2014 NEW YORK CITY FUEL GAS CODE 2014 NEW YORK CITY FIRE CODE 2010 ADA STANDARDS FOR ACCESSIBLE DESIGN 2010 NEW YORK CITY ENERGY CONSERVATION CODE (NYECC)

2014 BC ACCESSIBILITY CH. 11 AND 2009 - ANSI 117.1

PROJECT DESIGN DIRECTORY

E: FRANNIERABIN@GMAIL.COM

PROJECT MANAGER: MAX HUANG 118W 22ND STREET, 6TH FLOOR

PROJECT EXECUTIVE: MARY LANGAN

FRANNIE RABIN

MICHAEL RABIN

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DESIGN ARCHITECT

E: MRABINARCH@AOL.COM

NEW YORK CITY BUILDING DEPARTMENT NOTES

THESE NOTES ARE PART OF THE PLANS AND SPECIFICATIONS AND ARE TO BE COMPLIED WITH IN ALL RESPECTS. MORE RESTRICTIVE NOTES MENTIONED ELSEWHERE ARE TO TAKE PRECEDENCE OVER THE FOLLOWING:

1. ALL DEMOLITION/TEMPORARY CONSTRUCTION SHALL BE IN ACCORDANCE WITH THE RULES AND REGULATIONS OF THE NEW YORK CITY BUILDING CODE.

2. THE OWNER SHALL BE RESPONSIBLE FOR THE SAFE MAINTENANCE OF THE BUILDING AND FACILITIES (C26-105.1 THROUGH 3). 3. ALL MATERIALS, ASSEMBLIES, FORMS AND METHODS OF DEMOLITION/TEMPORARY CONSTRUCTION AND SERVICE EQUIPMENT SHALL COMPLY WITH THE REQUIREMENTS OF SECTION (C26-106.2) 27-131.

4. ALL ELEVATIONS SHALL BE REFERRED TO DATUM USED BY TOPOGRAPHIC BUREAU, BORO PRESIDENTS OFFICE OF MANHATTAN WHICH IS 2.75' ABOVE THE U.S. COAST AD GEODETIC SURVEY MEAN LEVEL DATUM AT SANDY HOOK. ALL ELEVATIONS INDICATED ARE ACTUAL ELEVATIONS AND REFER TO DATUM USED BY TOPOGRAPHICAL BUREAU, BORO PRESIDENT'S OFFICE MANHATTAN

5. AT LEAST 24 HOUR WRITTEN NOTICE SHALL BE GIVEN TO THE COMMISSIONER BEFORE COMMENCEMENT OF WORK. (C26-118.5)

6. A COPY OF THE LATEST SET OF D.O.B APPROVED DRAWINGS SHALL BE KEPT AT THE JOB SITE FOR REVIEW BY THE ARCHITECT. 7. FIVE DAYS PRIOR NOTICE SHALL BE GIVEN TO ADJOINING LOT OWNERS AFFECTED BY FOUNDATION, EARTHWORK, OR DEMOLITION. (C26-112.3) 27-165 AND (C26-113.3) 27-169.

8. WRITTEN DIMENSIONS ON THESE DRAWINGS SHALL HAVE PRECEDENCE OVER SCALED DIMENSIONS.

9. CONTRACTORS SHALL VERIFY AND BE RESPONSIBLE FOR ALL DIMENSIONS AND CONDITIONS ON THE JOB AND ARCHITECT'S OFFICE MUST BE NOTIFIED OF ANY VARIATIONS FROM THE DIMENSIONS AND CONDITIONS SHOWN BY THESE DRAWINGS.

10. ALL CONSTRUCTION, DIMENSIONS AND DETAILS SHALL CONCUR WITH AND BE DETERMINED FROM THESE DRAWINGS ONLY. 11. ALL MATERIALS AND CONSTRUCTION TO BE INCORPORATED IN THE WORK SHALL BE IN STRICT ACCORDANCE WITH THE LATEST EDITION OF THE ASTM SPECIFICATIONS APPLICABLE, AND TO CONFORM TO THE STANDARDS AND RECOMMENDATIONS

12. CONTRACTORS SHALL BE RESPONSIBLE FOR ADEQUATELY BRACING AND PROTECTING ALL WORK DURING CONSTRUCTION AGAINST DAMAGE, BREAKAGES, COLLAPSE, DISTORTIONS AND OFF ALIGNMENT ACCORDING TO APPLICABLE CODES, STANDARDS

STRUCTURAL ENGINEER

CHRISTIE ENGINEERING, PC

211 SOMERVILLE ROAD BEDMINSTER, NJ 07921

P: 908-470-1919

F: 908-470-1949

PROJECT MANAGER: SASHA ZONIC

SASHA@CHRISTIEENGINEERING.COM

THE VARIOUS TRADE INSTITUTES (A.C.I./A.I.S.C., ETC.) WHERE APPLICABLE. ALL MATERIALS INCORPORATED INTO THE WORK

13. DEMOLITION/TEMPORARY CONSTRUCTION SHALL COMPLY WITH ALL FEDERAL, STATE AND LOCAL CODES, ORDINANCES, RULES AND REGULATIONS PERTAINING TO LABOR AND MATERIALS. ALL NOTES HEREIN MENTIONED WITH THOSE ON THE VARIOUS DRAWINGS, SHALL APPLY TO ALL DRAWINGS AND FORM PART OF THE CONTRACT.

14. EACH CONTRACTOR WILL BE HELD STRICTLY RESPONSIBLE FOR HIS WORK. ANY DISCREPANCIES IN THE PLANS OR DETAILS SHALL BE CALLED TO THE ATTENTION OF THE ARCHITECT.

GENERAL NOTES - GENERAL CONTRACTOR

1. THE CONTRACTOR SHALL VERIFY ALL EXISTING SITE CONDITIONS AND DIMENSIONS. IMMEDIATELY CONTACT THE ARCHITECT IF DISCREPANCIES OCCUR OR ARE FOUND, PARTITION LINES SHALL BE LAID OUT AND DRAWN DIRECTLY ONTO THE EXISTING FLOOR SUBSTRATE OR EXISTING CONCRETE SLAB; ANY DISCREPANCIES FOUND SHALL BE IMMEDIATELY REPORTED TO THE ARCHITECT AND OWNER'S REPRESENTATIVE PRIOR TO

2. THE CONTRACTOR SHALL NOT, UNDER ANY CIRCUMSTANCES, SCALE THE DRAWINGS. DIMENSIONAL CLARIFICATIONS ARE TO BE DIRECTED TO THE

3. THE CONTRACTOR SHALL, PRIOR TO DEMOLITION/TEMPORARY CONSTRUCTION, COMPARE ALL RELEVANT DRAWINGS. REPORT ANY DISCREPANCIES IMMEDIATELY TO THE ARCHITECT. NO INFORMATION OR DETAILS ON THE DRAWINGS OF THIS PROJECT MAY BE USED WITHOUT THE WRITTEN AND EXPRESSED CONSENT OF THE ARCHITECT.

4. THE CONTRACTOR SHALL PROVIDE ALL LABOR, EQUIPMENT, AND MATERIALS NECESSARY TO COMPLETE THE WORK AS REQUIRED AND SHOWN. 5. THE CONTRACTOR SHALL BE RESPONSIBLE FOR OBTAINING ALL REQUIRED AND NECESSARY PERMITS, INSPECTIONS, AND APPROVALS AS REQUIRED BY THE LOCAL GOVERNING BODIES HAVING JURISDICTION.

6. ALL MATERIALS AND CONSTRUCTION METHODS SHALL CONFORM TO THE REQUIREMENTS OF ALL APPLICABLE BUILDING, MECHANICAL, ELECTRICAL AND SAFFTY LAWS IN PLACE CURRENT AND ENFORCED IN THE ILIRISDICTION (CITY AND STATE) WHERE THE PROJECT IS LOCATED. THE CONTRACTOR AND ALL SUB-CONTRACTORS SHALL BE RESPONSIBLE FOR ANY VIOLATION(S) OF THE SAME AND SHALL MAKE ALL WORK ACCEPTABLE TO THE LOCAL BUILDING DEPARTMENTS AND AGENCIES HAVING JURISDICTION WITHOUT EXTRA CHARGES.

7. THE CONTRACTOR SHALL MAINTAIN ALL EXISTING EXITS, CORRIDORS, AND DOORS WHERE APPLICABLE, FREE OF ANY AND ALL OBSTRUCTION AT ALL TIMES.

8. ALL CONSTRUCTION AND/OR DEMOLITION DEBRIS IS TO BE REMOVED IMMEDIATELY FROM THE SITE AND DISPOSED OF IN A LEGAL AND SECURE MANNER. GC TO ENSURE SITE IS LEFT BROOM CLEAN AT THE END OF EACH WORK DAY.

9. THE CONTRACTOR SHALL COORDINATE THE WORK OF ALL TRADES AND OVERSEE THAT ALL CUTTING AND/OR PATCHING REQUIRED FOR THE INSTALLATION OF ALL MATERIALS BY ALL TRADES IS PROPERLY EXECUTED AS DESCRIBED WITHIN THE SCOPE OF WORK AS SHOWN ON THE DRAWINGS OR OTHER RELATED / ISSUED DOCUMENTS.

10. CONTRACTOR IS RESPONSIBLE FOR FIELD VERIFYING THAT THERE IS ADEQUATE CLEARANCE ABOVE FINISHED CEILING HEIGHT SPECIFIED ON THE DRAWINGS TO ACCOMMODATE MECHANICAL DUCTWORK, EQUIPMENT, LIGHTING, FIXTURES, ETC. THE CONTRACTOR SHALL NOTIFY THE ARCHITECT IMMEDIATELY OF ANY DISCREPANCIES AND AWAIT CLARIFICATION PRIOR TO PROCEEDING WITH WORK.

11. PLEASE RECYCLE DEMOLITION AND CONSTRUCTION WASTE WHERE APPLICABLE.

12. CONTRACTOR SHALL COMPLY WITH ALL O.S.H.A. REQUIREMENTS.

PROTECTION NOTES - GENERAL CONTRACTOR

SHEET NO | SHEET TITLE

ARCHITECTURAL DRAWINGS

T-000.00 | COVER SHEET

Z-001.00 ZONING ANALYSIS

Z-002.00 EXISTING CONDITION

A-002.00 EXTERIOR ELEVATIONS

A-003.00 EXTERIOR ELEVATIONS

A-004.00 BUILDING SECTION G

A-006.00 BUILDING SECTION H

A-008.00 BUILDING SECTION E

Z-008.00 LPC MOCKUP PHOTOS

Z-003.00 RIVERSIDE DRIVE AND 81ST STREET BLOCKFRONT ELEVATION

A-001.00 PROPOSED ROOF PLANS & BUILDING MODEL WITH ROOF ADDITION

Z-004.00 ROOF STREET VIEW PHOTOS & MATERIAL SELECTION

Z-005.00 ROOF STREET VIEW PHOTOS & MATERIAL SELECTION

Z-006.00 ROOF STREET VIEW PHOTOS & MATERIAL SELECTION

Z-007.00 ROOF STREET VIEW PHOTOS & MATERIAL SELECTION

A-000.00 EXISTING ROOF PLANS & ROOF PHOTOS

A-005.00 BUILDING SECTION G STREET VIEW

A-007.00 BUILDING SECTION H STREET VIEW

A-009.00 BUILDING SECTION E STREET VIEW

A-100.00 CELLAR FLOOR CONSTRUCTION PLAN

A-101.00 1ST FLOOR CONSTRUCTION PLAN

A-102.00 2ND FLOOR CONSTRUCTION PLAN

A-103.00 3RD FLOOR CONSTRUCTION PLAN

A-104.00 4TH FLOOR CONSTRUCTION PLAN

A-105.00 5TH FLOOR CONSTRUCTION PLAN

G.C. TO PROTECT, COVER AND SEAL ALL WOODWORK, MILLWORK, MOLDINGS, CASINGS, PANELING, FIREPLACES, FIRE-SLEEVES, METALS, HEARTH TILE AND HEARTHSTONES: SILLS AND DOORS SCHEDULED TO REMAIN IN ROOMS: 103, 105, 106, 110, 201, 204, 205, 305, 309, 401, 404, 501: All WINDOWS, SILLS AND UNDER-SILL PANELS AND CASINGS AND MAIN STAIR, BANISTERS, RAILINGS AND POSTS. ALL ITEMS AND ELEMENTS ARE SCHEDULED TO REMAIN AND SHALL BE REUSED OR RESTORED. G.C. TO PROTECT IN A SUPERVISED, SEALED AND SOLID ENCLOSURE WHERE NEEDED TO PREVENT DAMAGE DURING DEMOLITION.

ABBREVIATIONS

AIR CONDITIONING

ACRYLIC

ACCS

BLDG

BOH

CLG CLOS CLR

COL

CONT

DWG

ETC

ELV

DIAMETER

DIMENSION

DOWN

DRAWING

ETCETERA

ELEVATION

ELEC ELECTRICAL

EXISTING

ACCESSORY **EXTERIOR** MFR MANUFACTURER ACOUSTIC CEILING TILE FINISH FLOOR AMERICANS WITH MISC MISCELLANEOUS FIRE TREATED MIN DISABILLITIES ACT FINISH SPEC ADDEMDUM FIXTURE MOUNTED ABOVE FINISHED FLOOP MTL METAL SQ FT SQUARE FEET FLR FLOOR ARCHITECTURAL / ARCHITECT MAKE-UP UNIT FOOT / FEET ST STONE GAUGE STD STANDARD / STANDARDS AMERICAN SOCIETY FOR GALV GALVANIZED STRUCT STRUCTURE / STRUCTURAL NOT IN CONTRACT **TESTING & MATERIALS** GEN GENERAL APPVD APPROVED NOT TO SCALE GLASS ST STL STAINLESS STEEL ON CENTER GRANITE SUSP SUSPENDED BUILDING OUTSIDE DIAMETER GWB GYPSUM WALLBOARD BOTTOM OF GYP GYPSUM BACK OF HOUSE PARTITION HANDICAPPED CENTER LINE PRIVATE MAKE-UP ROOM HDWR HARDWARF PLAM PLASTIC LAMINATE CEILING **HEAVY GAUGE** CLOSET PLYWD PLYWOOD HOLLOW METAL CLEAR PRE-FAB PRE-FABRICATED HORIZONTAL T.O.W. TOP OF WALL CENTIMETER HOUR CONCRETE MASONRY UNIT HEIGHT COLUMN HEATING/VENTILATION/ U.O.N. CONC CONCRETE RISER AIR-CONTITIONING CONTINUOUS / CONTINUED RADIUS INTERNATIONAL BUILDING CODE REFLECTED CELLING PLAN RCP COORD COORDINATE

ELECTRICAL PANEL

JOINT

LAM

LAV

LAMINATED

LAVATORY

POUNDS

METER

MAXIMUM

MACH MACHINE

INSIDE DIAMETER REF REFERENCE / REFERENCE REQ'D REQUIRED REV REVISION RM ROOM R.O. ROUGH OPENING RVL REVEAL SUSPENDED CEILING

MECH MECHANICAL

MEZZANINE

LEASE LINE MEDIUM DENSITY FIBERBOARD

VEST VESTIBULE VFRIFY IN FIELD WEST WOOD WALLPAPER WITH

SCH SCHEDULE

SECT SECTION

SIMILAR

SPECIFICATION

TO BE DETERMINED

TONGUE AND GROOVE

UNIFORM BUILDING CODE

UNLESS OTHERWISE NOTED

CINYL COMPOSITE TILE

UNDERWRITERS LABORATORIE

THICK / THICKNESS

TELEPHONE

TEMPORARY

TOP OF

TYPICAL

UNDERSIDE

SQUARE FEET / SQUARE FOOTAG

10024 DRIVE SIDE

O'NEIL LANGAN

ARCHITECTS

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MEP ENGINEER



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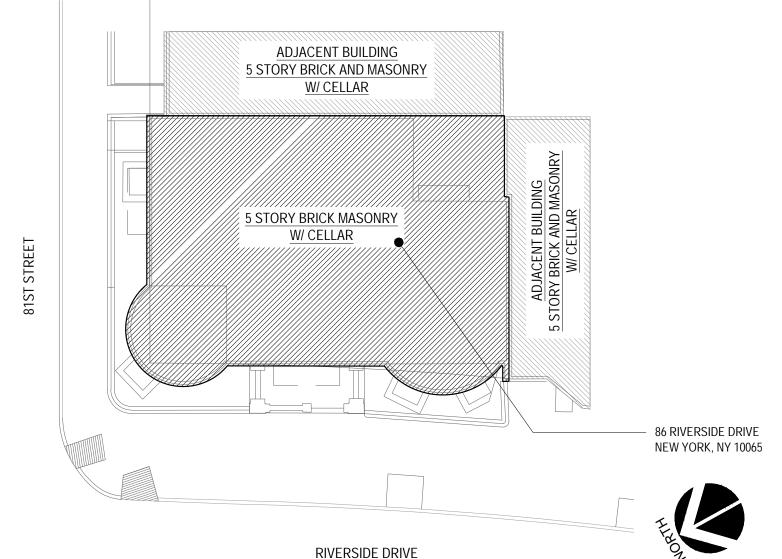
DATE: 06.01.2021 DRAWN BY: MH CHECKED BY: SC/ML AREA: 9698 SQ FT # ISSUE

DATE FOR LPC AND PERMIT 06/17/202 FOR LPC AND PERMIT FOR COMMUNITY BOARD HEARING 08/05/20 FOR COMMUNITY BOARD HEARING 08/11/20 FOR LPC AND PERMIT


COVER SHEET

T-000.00

SITE PLAN DIAGRAM: NOT TO SCALE




PROJECT LOCATION: NOT TO SCALE

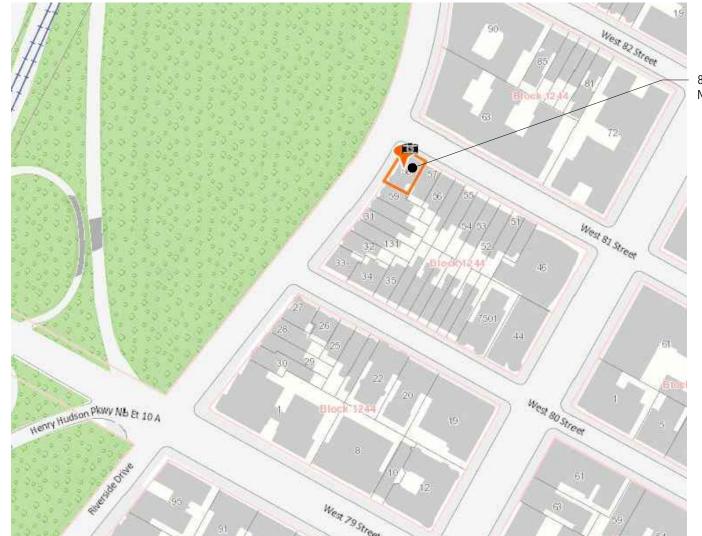


A-106.00 6TH FLOOR CONSTRUCTION PLAN A-107.00 ROOF FLOOR CONSTRUCTION PLAN 86 RIVERSIDE DRIVE NEW YORK, NY 10065

NOTE: THIS PROPERTY IS NOT LOCATED IN AN AREA THAT MAY BE AFFECTED BY TIDAL WETLANDS. FRESH WATER WETLANDS, COASTAL EROSION, HAZARD AREA, OR SPECIAL FLOOD AREA.

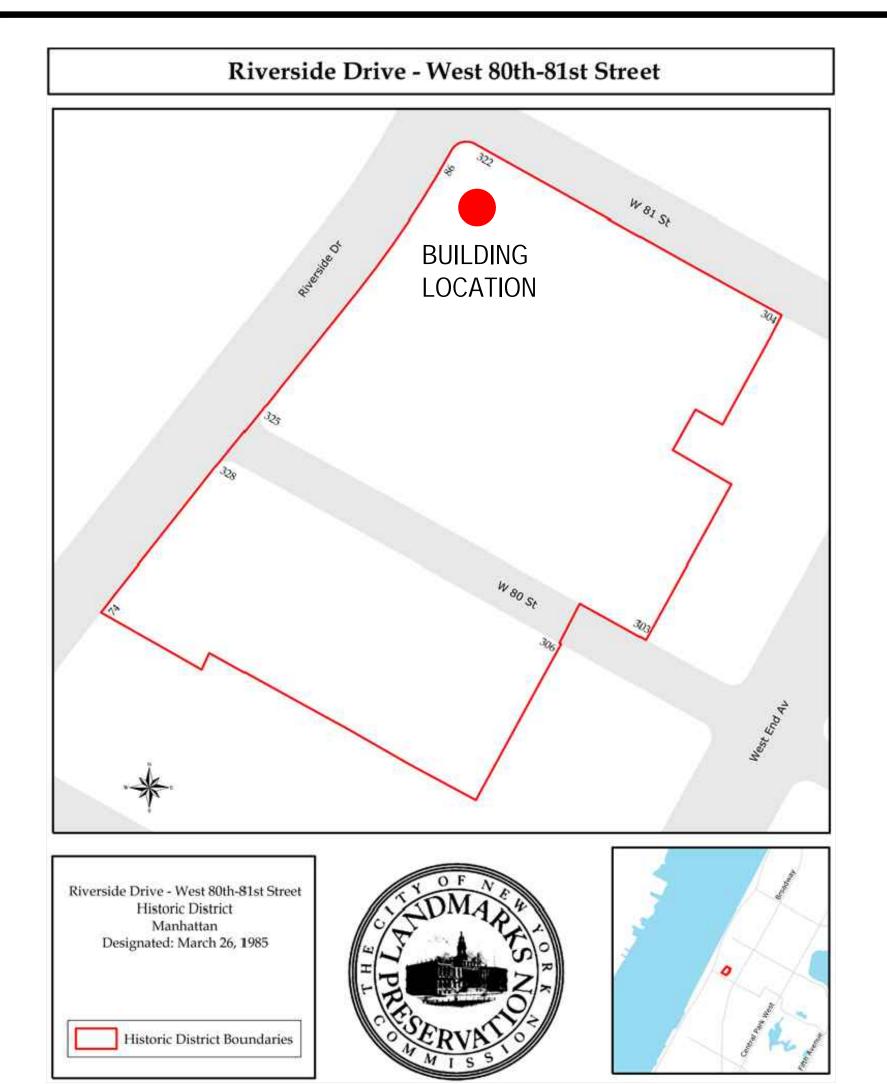

ZONING MAP SCALE: N.T.S.

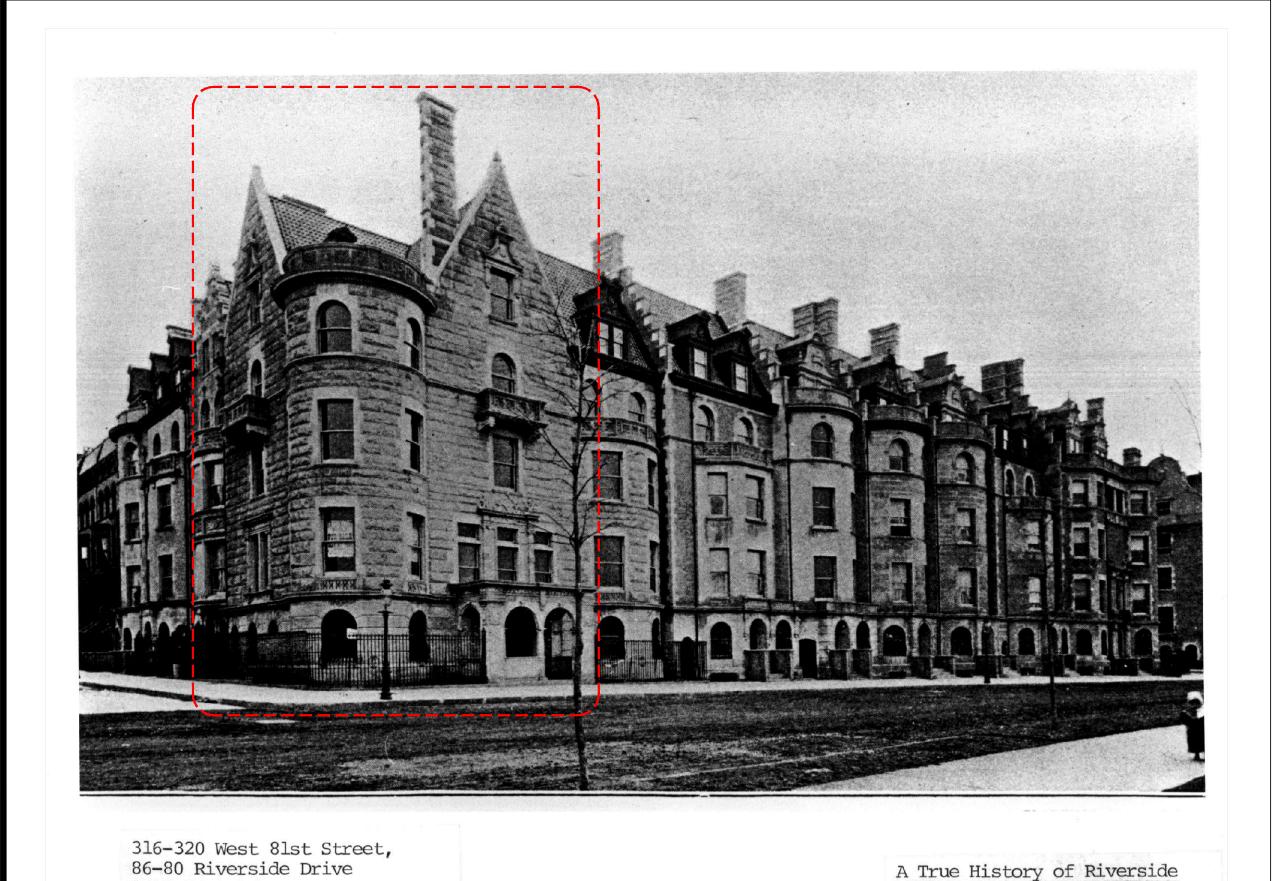

A True History of Riverside

Drive, Clarence True

JOB NO. M 1244-58-TO SURVEYED ON: APRIL 8, 2021 FLOOD NOTE

BY GRAPHIC PLOTTING ONLY, SUBJECT PROPERTY IS LOCATED IN

ZONE X (AREA OF NO FLOODING) SHOWN ON THE FLOODINS DIFFANCE MATE MAP FOR COMMUNITY PANEL NUMB 360 497 0086 F WHICH BEARS AN EFFECTIVE DATE OF SEPTEMBER 5, 2007. ZONE X (AREA OF NO FLOODING) AS SHOWN ON THE PRELIMINARY FEMA MAP PANEL NUMBER 360 497 0086 G REVISED ON JANUARY 30, 2015. E STREET 48.76 48.66 × 47.6 5 STY BRICK AND MASONRY W/ CELLAR F.FL.EL.50.05 5th FLOOR ▼ EL.93.76 MASONRY W/ CELLAR PARALLEL WITH WEST END AVENUE 4th FLOOR **51'-8"**PARALLEL WITH
WEST END AVENUE 3rd FLOOR 2nd FLOOR EL.59.80 1st FLOOR ROOF ROOF × 104.63 × EL.105.14 CELLAR ROOF ELEVATIONS WEST END 100'WIDE AVENUE

O'NEIL LANGAN ARCHITECTS

> 118 WEST 22ND ST 6TH FLOOR NEW YORK, NY 10011 PHONE: 212-279-2670 FAX: 212-279-2671


MEP ENGINEER

STRUCTURAL ENGINEER

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10024 86 RIVERSIDE I NEW YORK, NY YORK, NY



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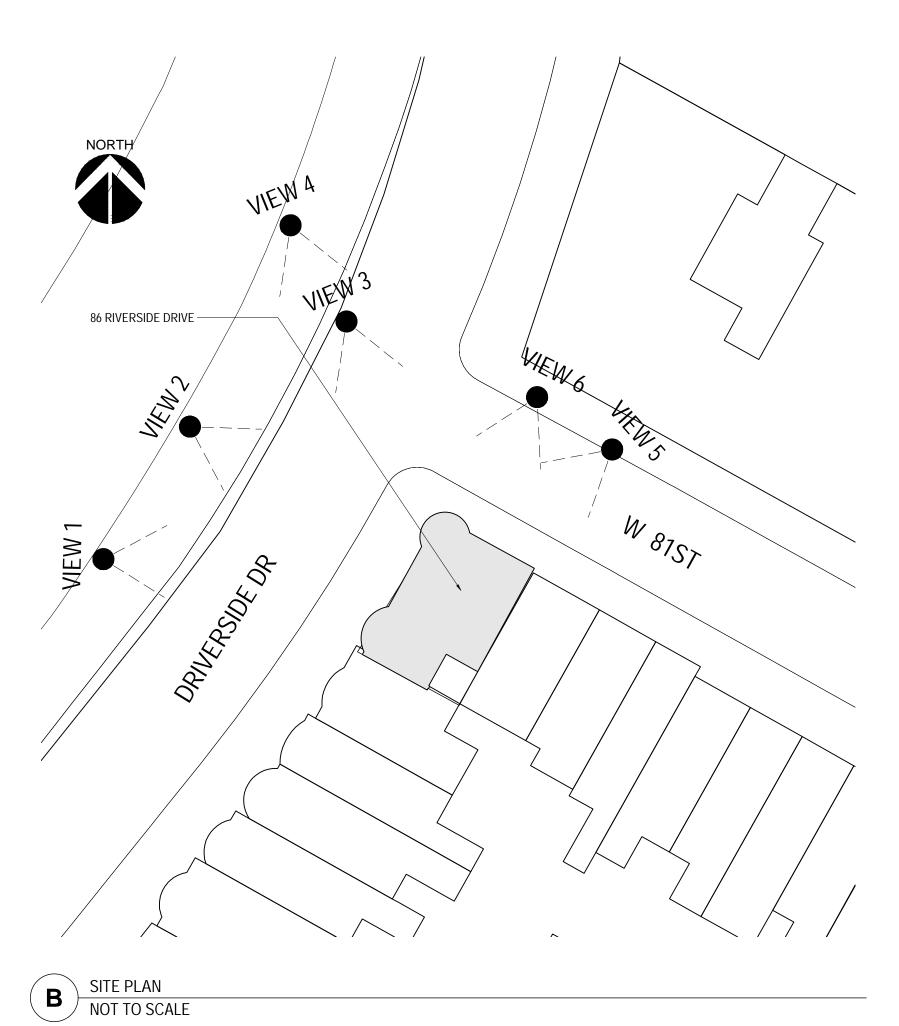
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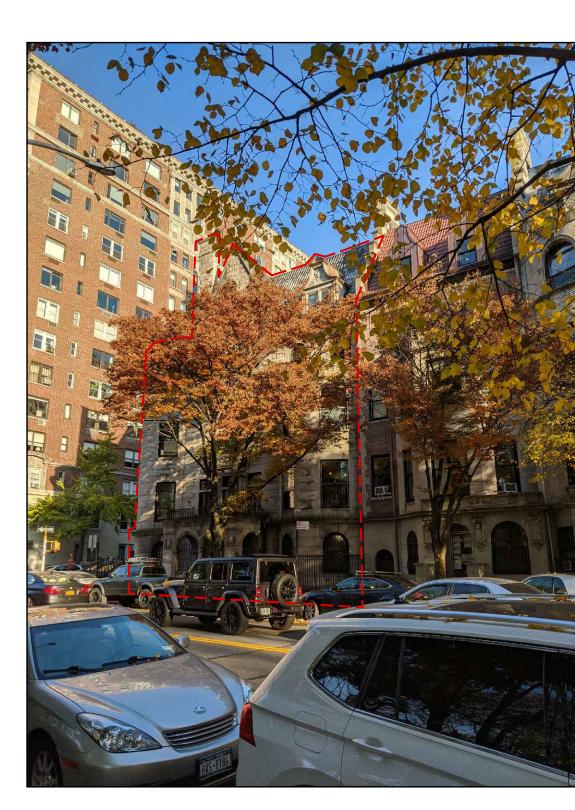
DATE 06/17/202 FOR LPC AND PERMIT FOR COMMUNITY BOARD HEARING 08/05/202 FOR COMMUNITY BOARD HEARING 08/11/202

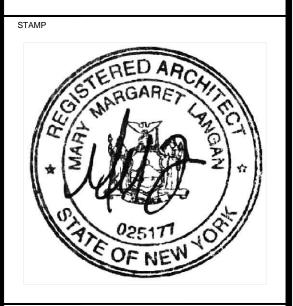ZONING ANALYSIS


1897-98, Clarence True

A AERIAL VIEW OF 86 DRIVERSIDE DR
NOT TO SCALE






FACADE PICTURE VIEW 1
NOT TO SCALE

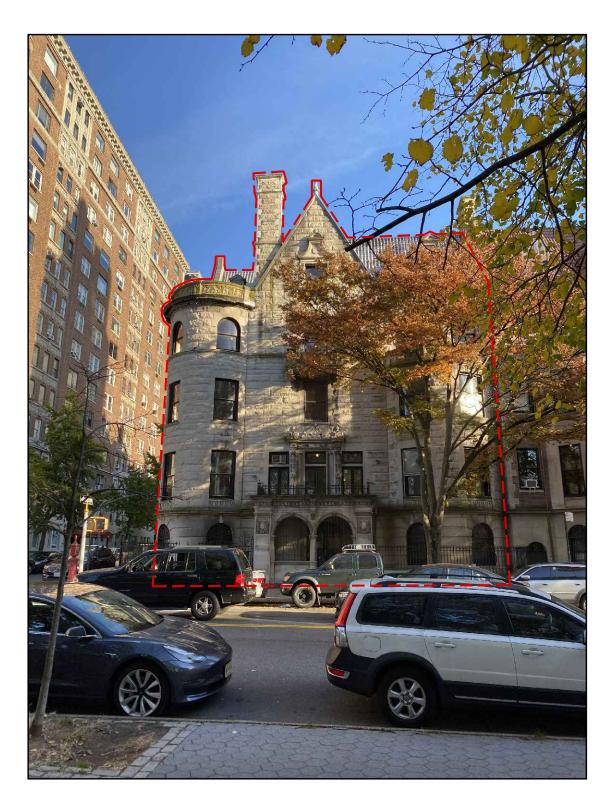


PACADE PICTURE VIEW 2
NOT TO SCALE




FACADE PICTURE VIEW 3
NOT TO SCALE

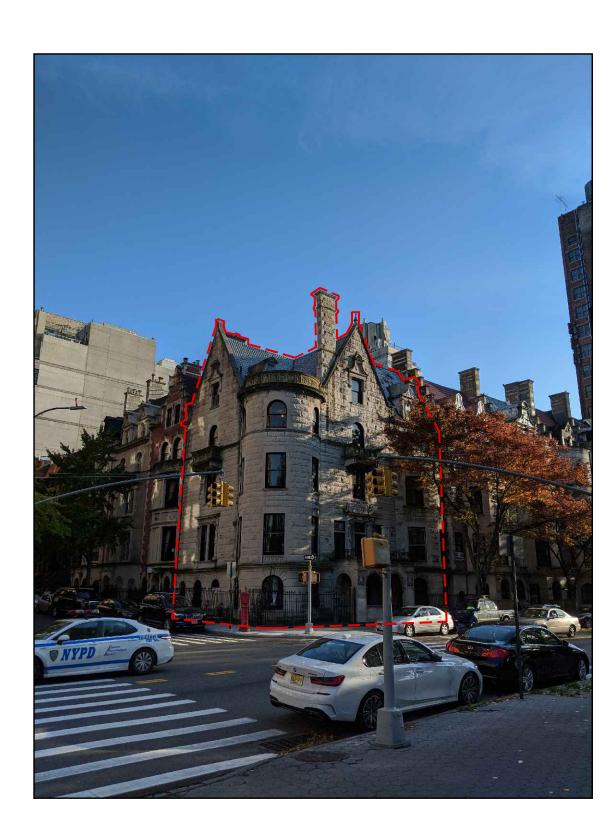

FACADE PICTURE VIEW 4
NOT TO SCALE

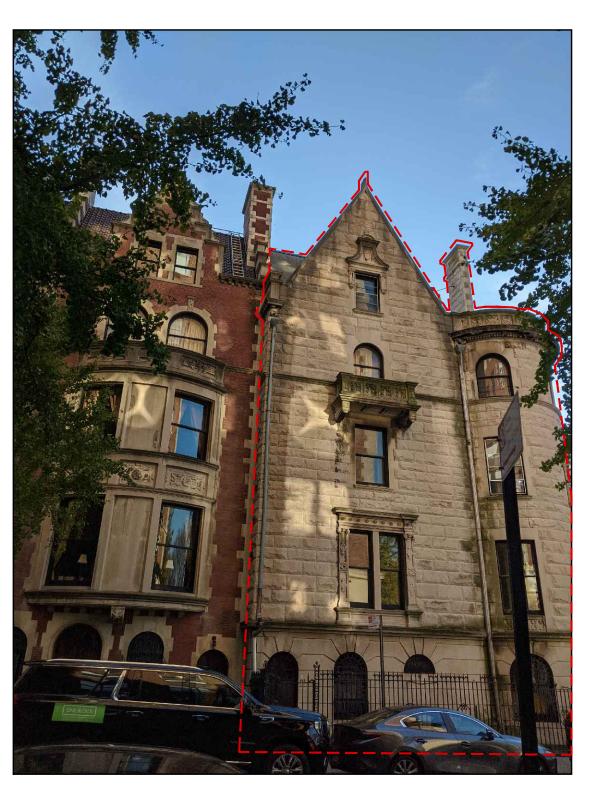

FACADE PICTURE VIEW 5
NOT TO SCALE

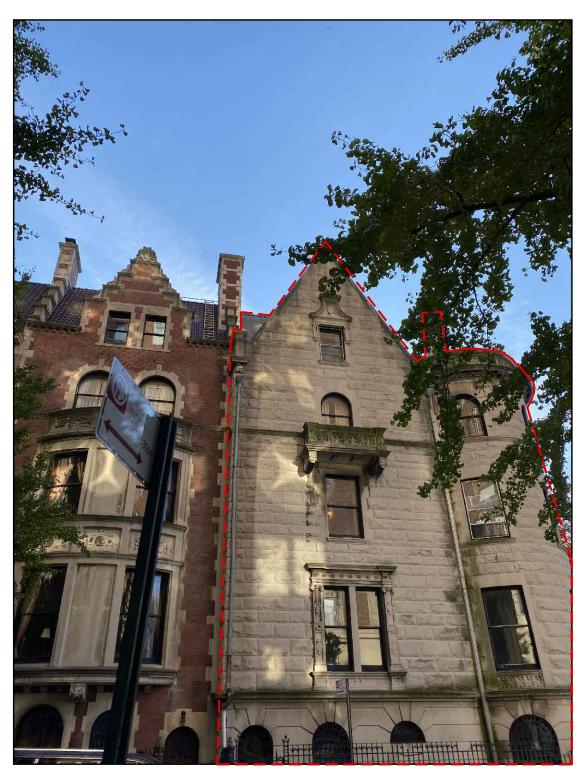

6 FACADE PICTURE VIEW 6
NOT TO SCALE

ARCHITECT

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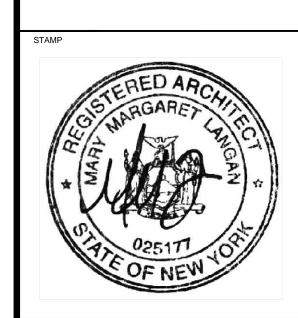
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86 RIVERSIDE DRIVE NEW YORK, NY 10024



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AREA: 9698 SQ FT				
#	ISSUE	DATE		
	FOR LPC AND PERMIT	06/17/2022		
	FOR LPC AND PERMIT	07/29/2022		
	FOR COMMUNITY BOARD HEARING	08/05/2022		

FOR COMMUNITY BOARD HEARING 08/11/202

HEET TITLE

PROJECT NO.: 221163

EXISTING CONDITION

Z-002.00




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FOR LPC AND PERMIT FOR LPC AND PERMIT FOR COMMUNITY BOARD HEARING 08/05/202 FOR COMMUNITY BOARD HEARING 08/11/202

RIVERSIDE DRIVE AND 81ST STREET BLOCKFRONT ELEVATION







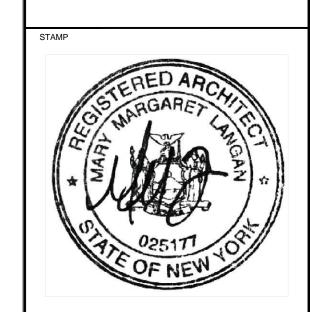


STREET VIEW A AT THE CORNER OF 81ST STREET AND RIVERSIDE DRIVE EXISTING PHOTO

STREET VIEW PHOTOS AND PROPOSED NEW ROOF WITH MATERIALS




[MT-1] ARCHITECTURAL METAL CLADDING AND MULLION SYSTEM COLOR/FINISH: GRANUM SKYGREY

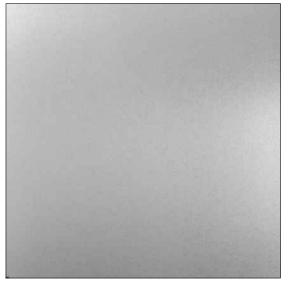

[MT-2] MILD 316 STEEL CABLE RAILING SYSTEMS



[MT-3] STAINLESS STEEL FLUE PIPE

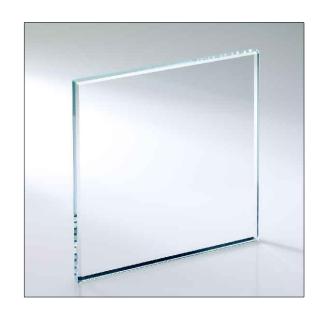


[GL-1] GLASS



[ST-1] BULKHEAD CLADDING -PETRARCH ENGINEERED STONE PANEL COLOR/FINISH: LIMESTONE RIVEN MATT



[GW-1] GREEN WALL AT THE CONDENSERS

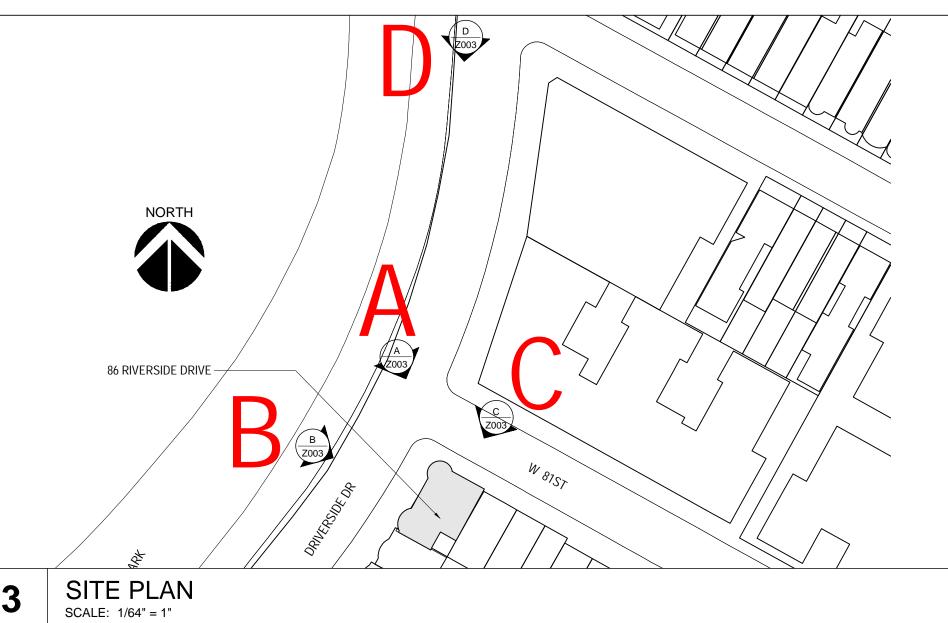

O'NEIL LANGAN ARCHITECTS

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Christie Engineering, P.C.

DRIVE / 10024



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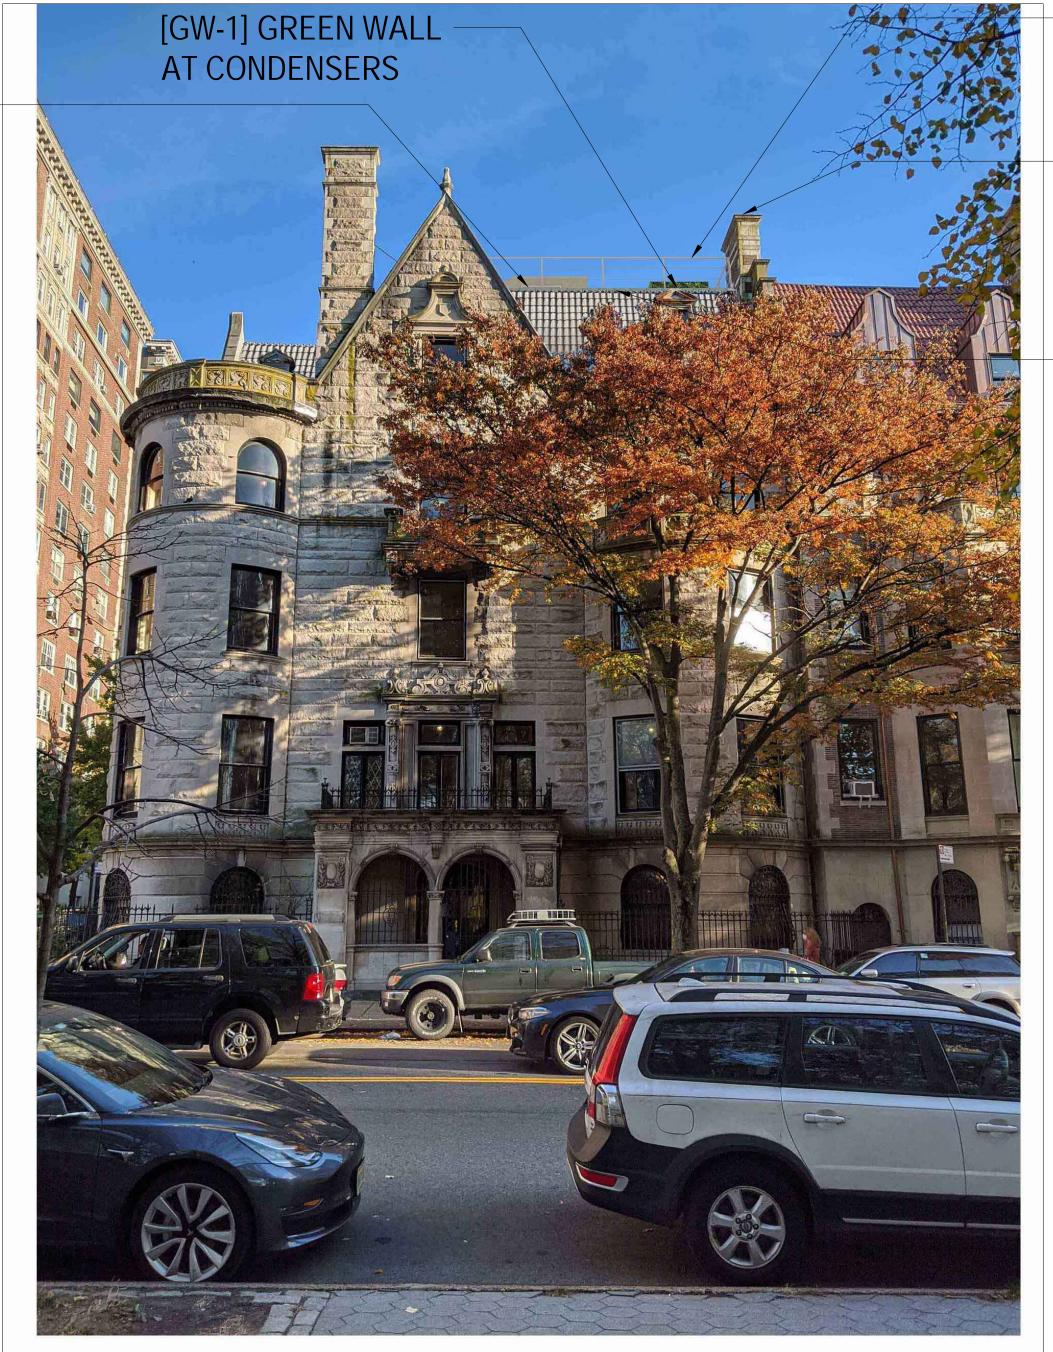
AREA: 9698 SQ FT ISSUE FOR LPC AND PERMIT

DATE 06/17/202 FOR COMMUNITY BOARD HEARING 08/05/202 FOR COMMUNITY BOARD HEARING 08/11/202

ROOF STREET VIEW PHOTOS & MATERIAL SELECTION



[ST-1] STAIR BULKHEAD CLADDING - PETRARCH ENGINEERED STONE PANEL - LIMESTONE RIVEN MATT



[MT-2] MILD 316 STEEL CABLE RAILING SYSTEMS

[MT-3] METAL CHIMNEY EXTENSION WON'T BE SEEN ON STREET

[MT-1] ARCHITECTURAL METAL CLADDING OVER RAISED FACADE -GRANUM SKYGREY

O'NEIL LANGAN

ARCHITECTS 118 WEST 22ND ST 6TH FLOOR NEW YORK, NY 10011 PHONE: 212-279-2670 FAX: 212-279-2671

MEP ENGINEER

STRUCTURAL ENGINEER

Christie Engineering, P.C.

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AREA: 9698 SQ FT

FOR LPC AND PERMIT FOR COMMUNITY BOARD HEARING 08/05/20 FOR COMMUNITY BOARD HEARING 08/11/20


ROOF STREET VIEW PHOTOS & MATERIAL SELECTION

STREET VIEW B ON THE RIVERSIDE DRIVE

STREET VIEW PHOTOS AND PROPOSED NEW ROOF WITH MATERIALS




[MT-1] ARCHITECTURAL METAL CLADDING AND MULLION SYSTEM COLOR/FINISH: GRANUM SKYGREY

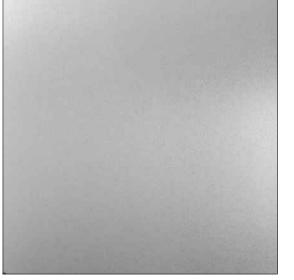

[MT-2] MILD 316 STEEL CABLE RAILING SYSTEMS



[MT-3] STAINLESS STEEL FLUE PIPE

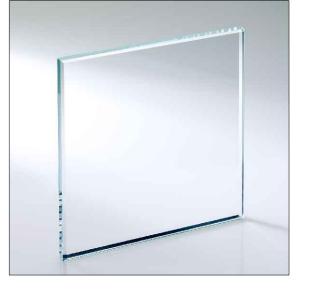

[GL-1] GLASS




[ST-1] BULKHEAD CLADDING -PETRARCH ENGINEERED STONE PANEL COLOR/FINISH: LIMESTONE RIVEN MATT



STREET VIEW B ON THE RIVERSIDE DRIVE
PROPOSED NEW ROOF RENDERED WITH MATERIALS

[GW-1] GREEN WALL AT THE CONDENSERS

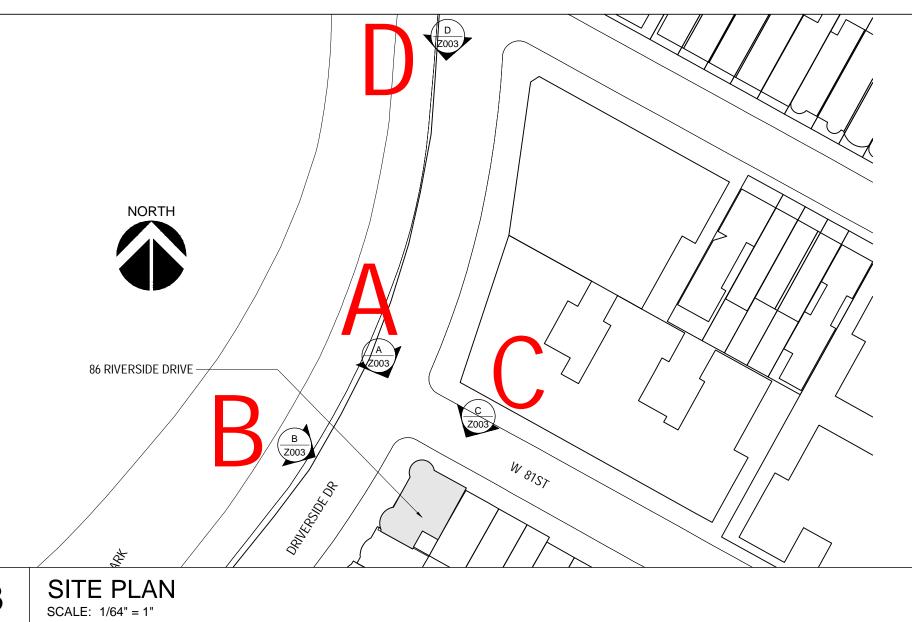





STREET VIEW C ON THE 81ST STREET
PROPOSED NEW ROOF RENDERED WITH MATERIALS

STREET VIEW PHOTOS AND PROPOSED NEW ROOF WITH MATERIALS SCALE: NOT TO SCALE



[MT-1] ARCHITECTURAL METAL CLADDING AND MULLION SYSTEM COLOR/FINISH: GRANUM SKYGREY



[MT-2] MILD 316 STEEL CABLE RAILING SYSTEMS



[MT-3] STAINLESS STEEL FLUE PIPE




[GL-1] GLASS



[ST-1] BULKHEAD CLADDING -PETRARCH ENGINEERED STONE PANEL COLOR/FINISH: LIMESTONE RIVEN MATT



[GW-1] GREEN WALL AT THE CONDENSERS

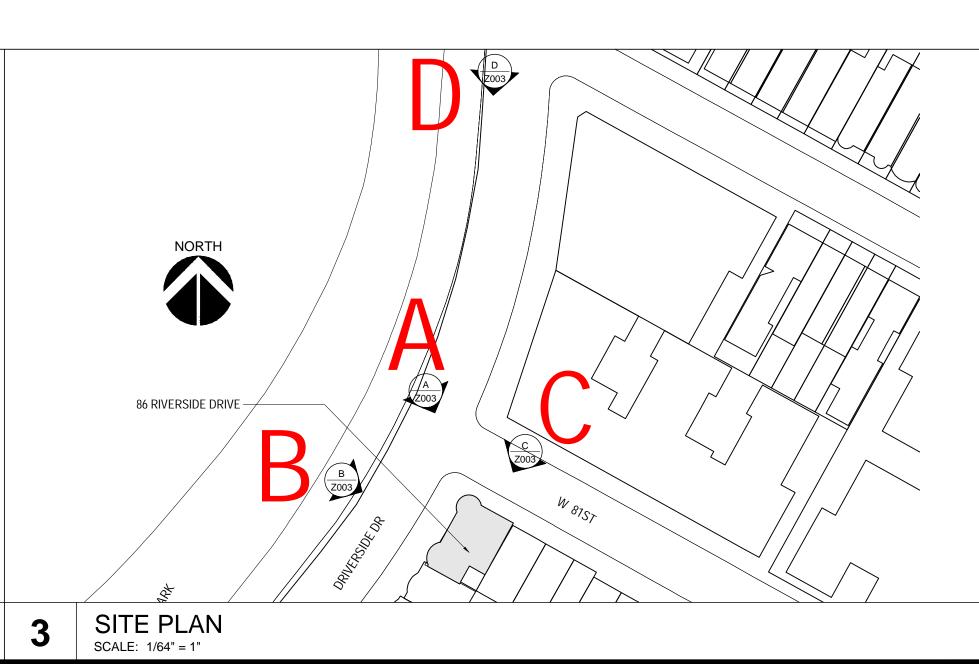

O'NEIL LANGAN

ARCHITECTS

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MEP ENGINEER

Christie Engineering, P.C.

211 SOMERVILLE ROAD BEDMINSTER, NJ 07921 PHONE: 908-470-1919 FAX: 908-470-1949

10024 86 RIVERSIDE NEW YORK, NY



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AREA: 9698 SQ FT ISSUE FOR LPC AND PERMIT FOR LPC AND PERMIT FOR COMMUNITY BOARD HEARING 08/05/202

FOR COMMUNITY BOARD HEARING 08/11/202


DATE 06/17/202

ROOF STREET VIEW PHOTOS & MATERIAL SELECTION

FOR LPC AND PERMIT



[ST-1] STAIR BULKHEAD **CLADDING - PETRARCH** ENGINEERED STONE PANEL -LIMESTONE RIVEN MATT [GL-1] GLASS SKYLIGHT ON THE STAIR BULKHEAD [ST-1] ELEVATOR BULKHEAD CLADDING - PETRARCH ENGINEERED STONE PANEL -LIMESTONE RIVEN MATT

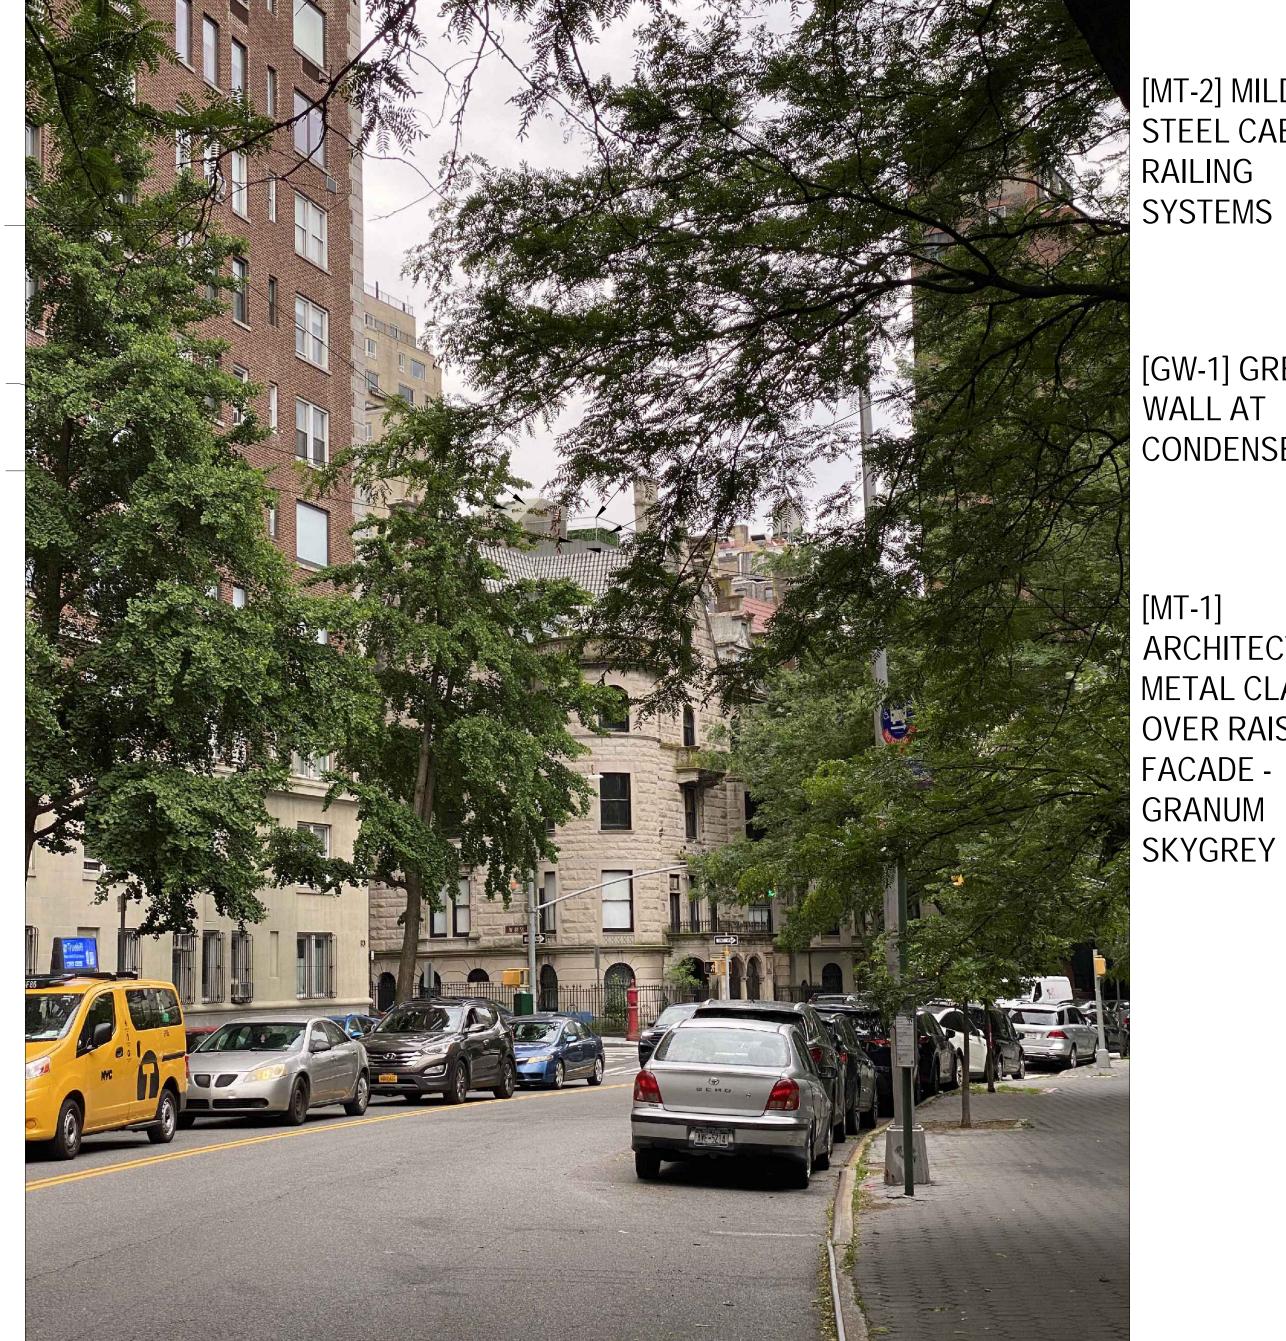

[MT-2] MILD 316 STEEL CABLE RAILING **SYSTEMS**

> [GW-1] GREEN WALL AT CONDENSERS

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MEP ENGINEER

[MT-1] ARCHITECTURAL METAL CLADDING OVER RAISED FACADE -GRANUM

DRIVE / 10024

STREET VIEW C ON THE 81ST STREET
EXISTING PHOTO

STREET VIEW C ON THE 81ST STREET
PROPOSED NEW ROOF RENDERED WITH MATERIALS

STREET VIEW PHOTOS AND PROPOSED NEW ROOF WITH MATERIALS




[MT-1] ARCHITECTURAL METAL CLADDING AND MULLION SYSTEM COLOR/FINISH: GRANUM SKYGREY



[MT-2] MILD 316 STEEL CABLE RAILING SYSTEMS



[MT-3] STAINLESS STEEL FLUE PIPE

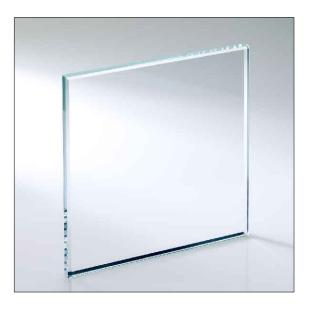


[GL-1] GLASS



[ST-1] BULKHEAD CLADDING -PETRARCH ENGINEERED STONE PANEL COLOR/FINISH: LIMESTONE RIVEN MATT



[GW-1] GREEN WALL AT THE CONDENSERS

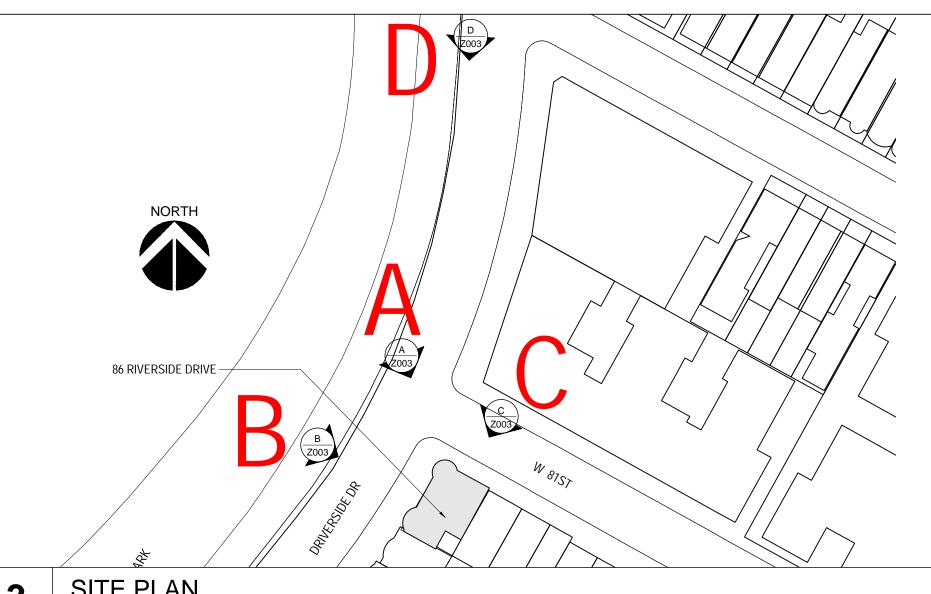

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ROOF STREET VIEW PHOTOS & MATERIAL SELECTION


PROPOSED ROOF MATERIAL PALETTE SCALE: N.T.S.

SITE PLAN SCALE: 1/64" = 1"

[ST-1] STAIR BULKHEAD CLADDING - PETRARCH ENGINEERED STONE PANEL -LIMESTONE RIVEN MATT

[GL-1] GLASS SKYLIGHT ON THE STAIR BULKHEAD

[ST-1] ELEVATOR BULKHEAD CLADDING - PETRARCH ENGINEERED STONE PANEL -LIMESTONE RIVEN MATT

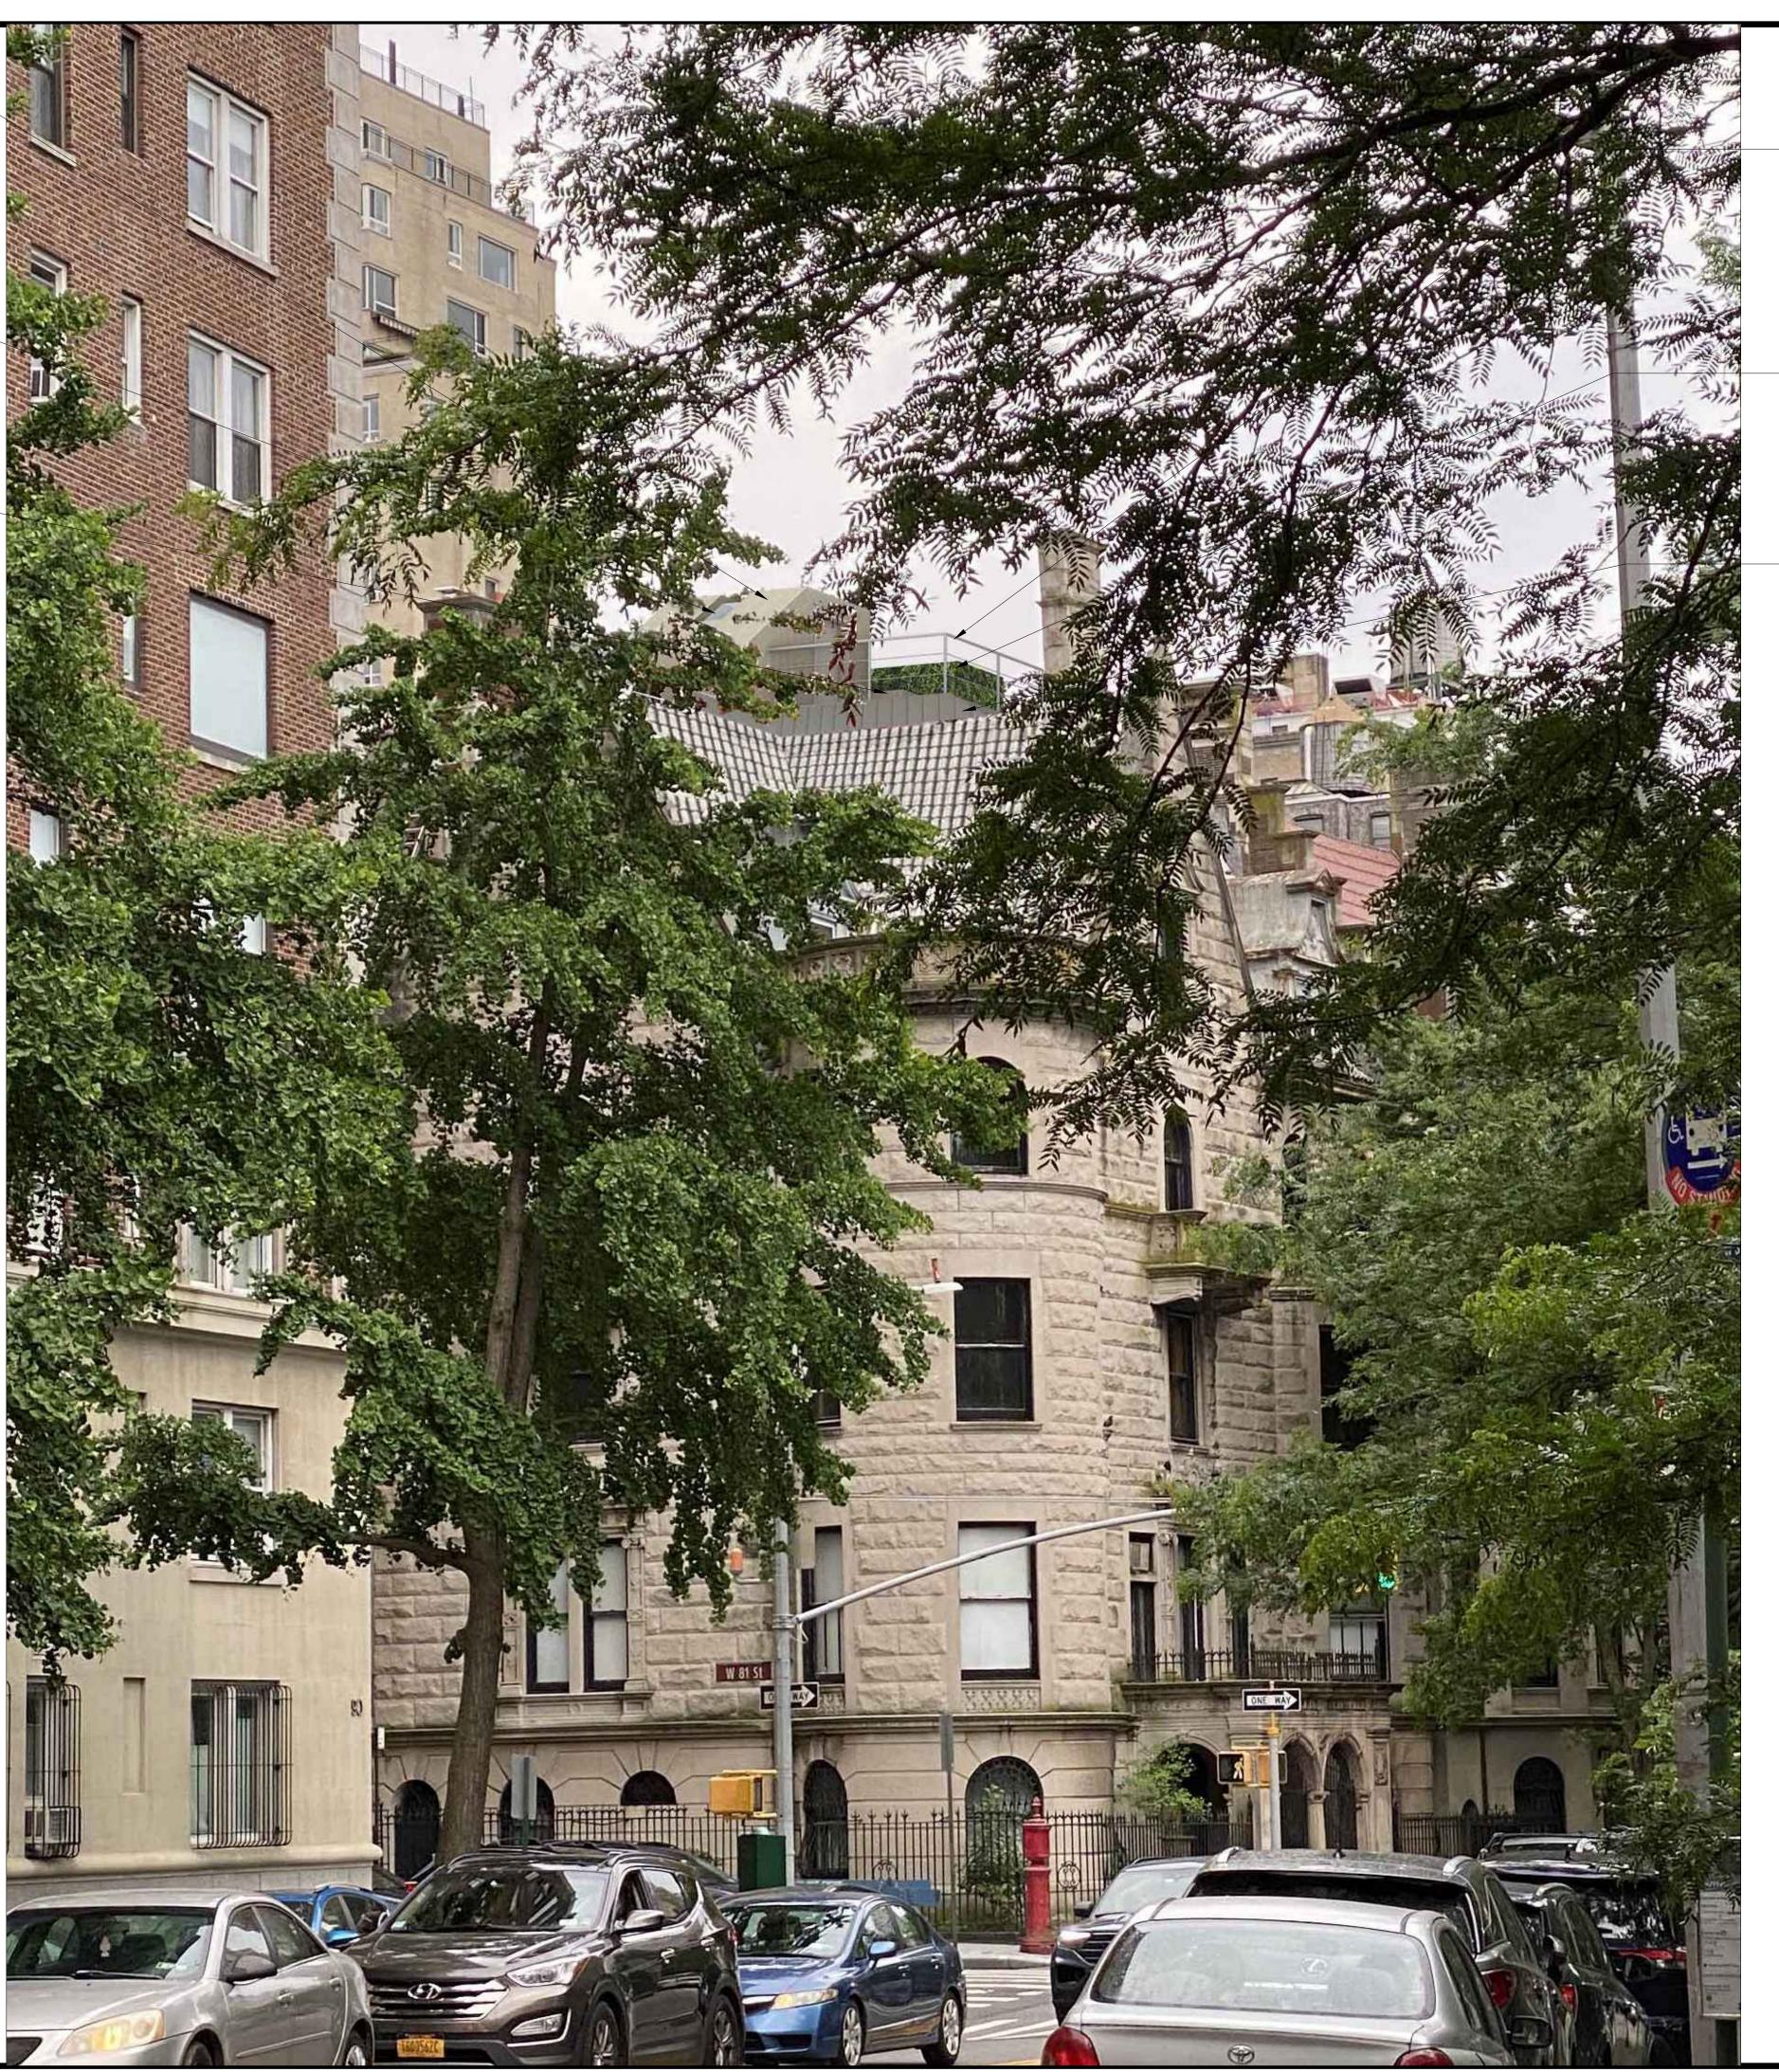

[MT-2] MILD 316 STEEL CABLE RAILING SYSTEMS

[GW-1] GREEN WALL AT CONDENSERS

[MT-1] ARCHITECTURAL METAL CLADDING OVER RAISED FACADE -GRANUM SKYGREY

ARCHITECTS


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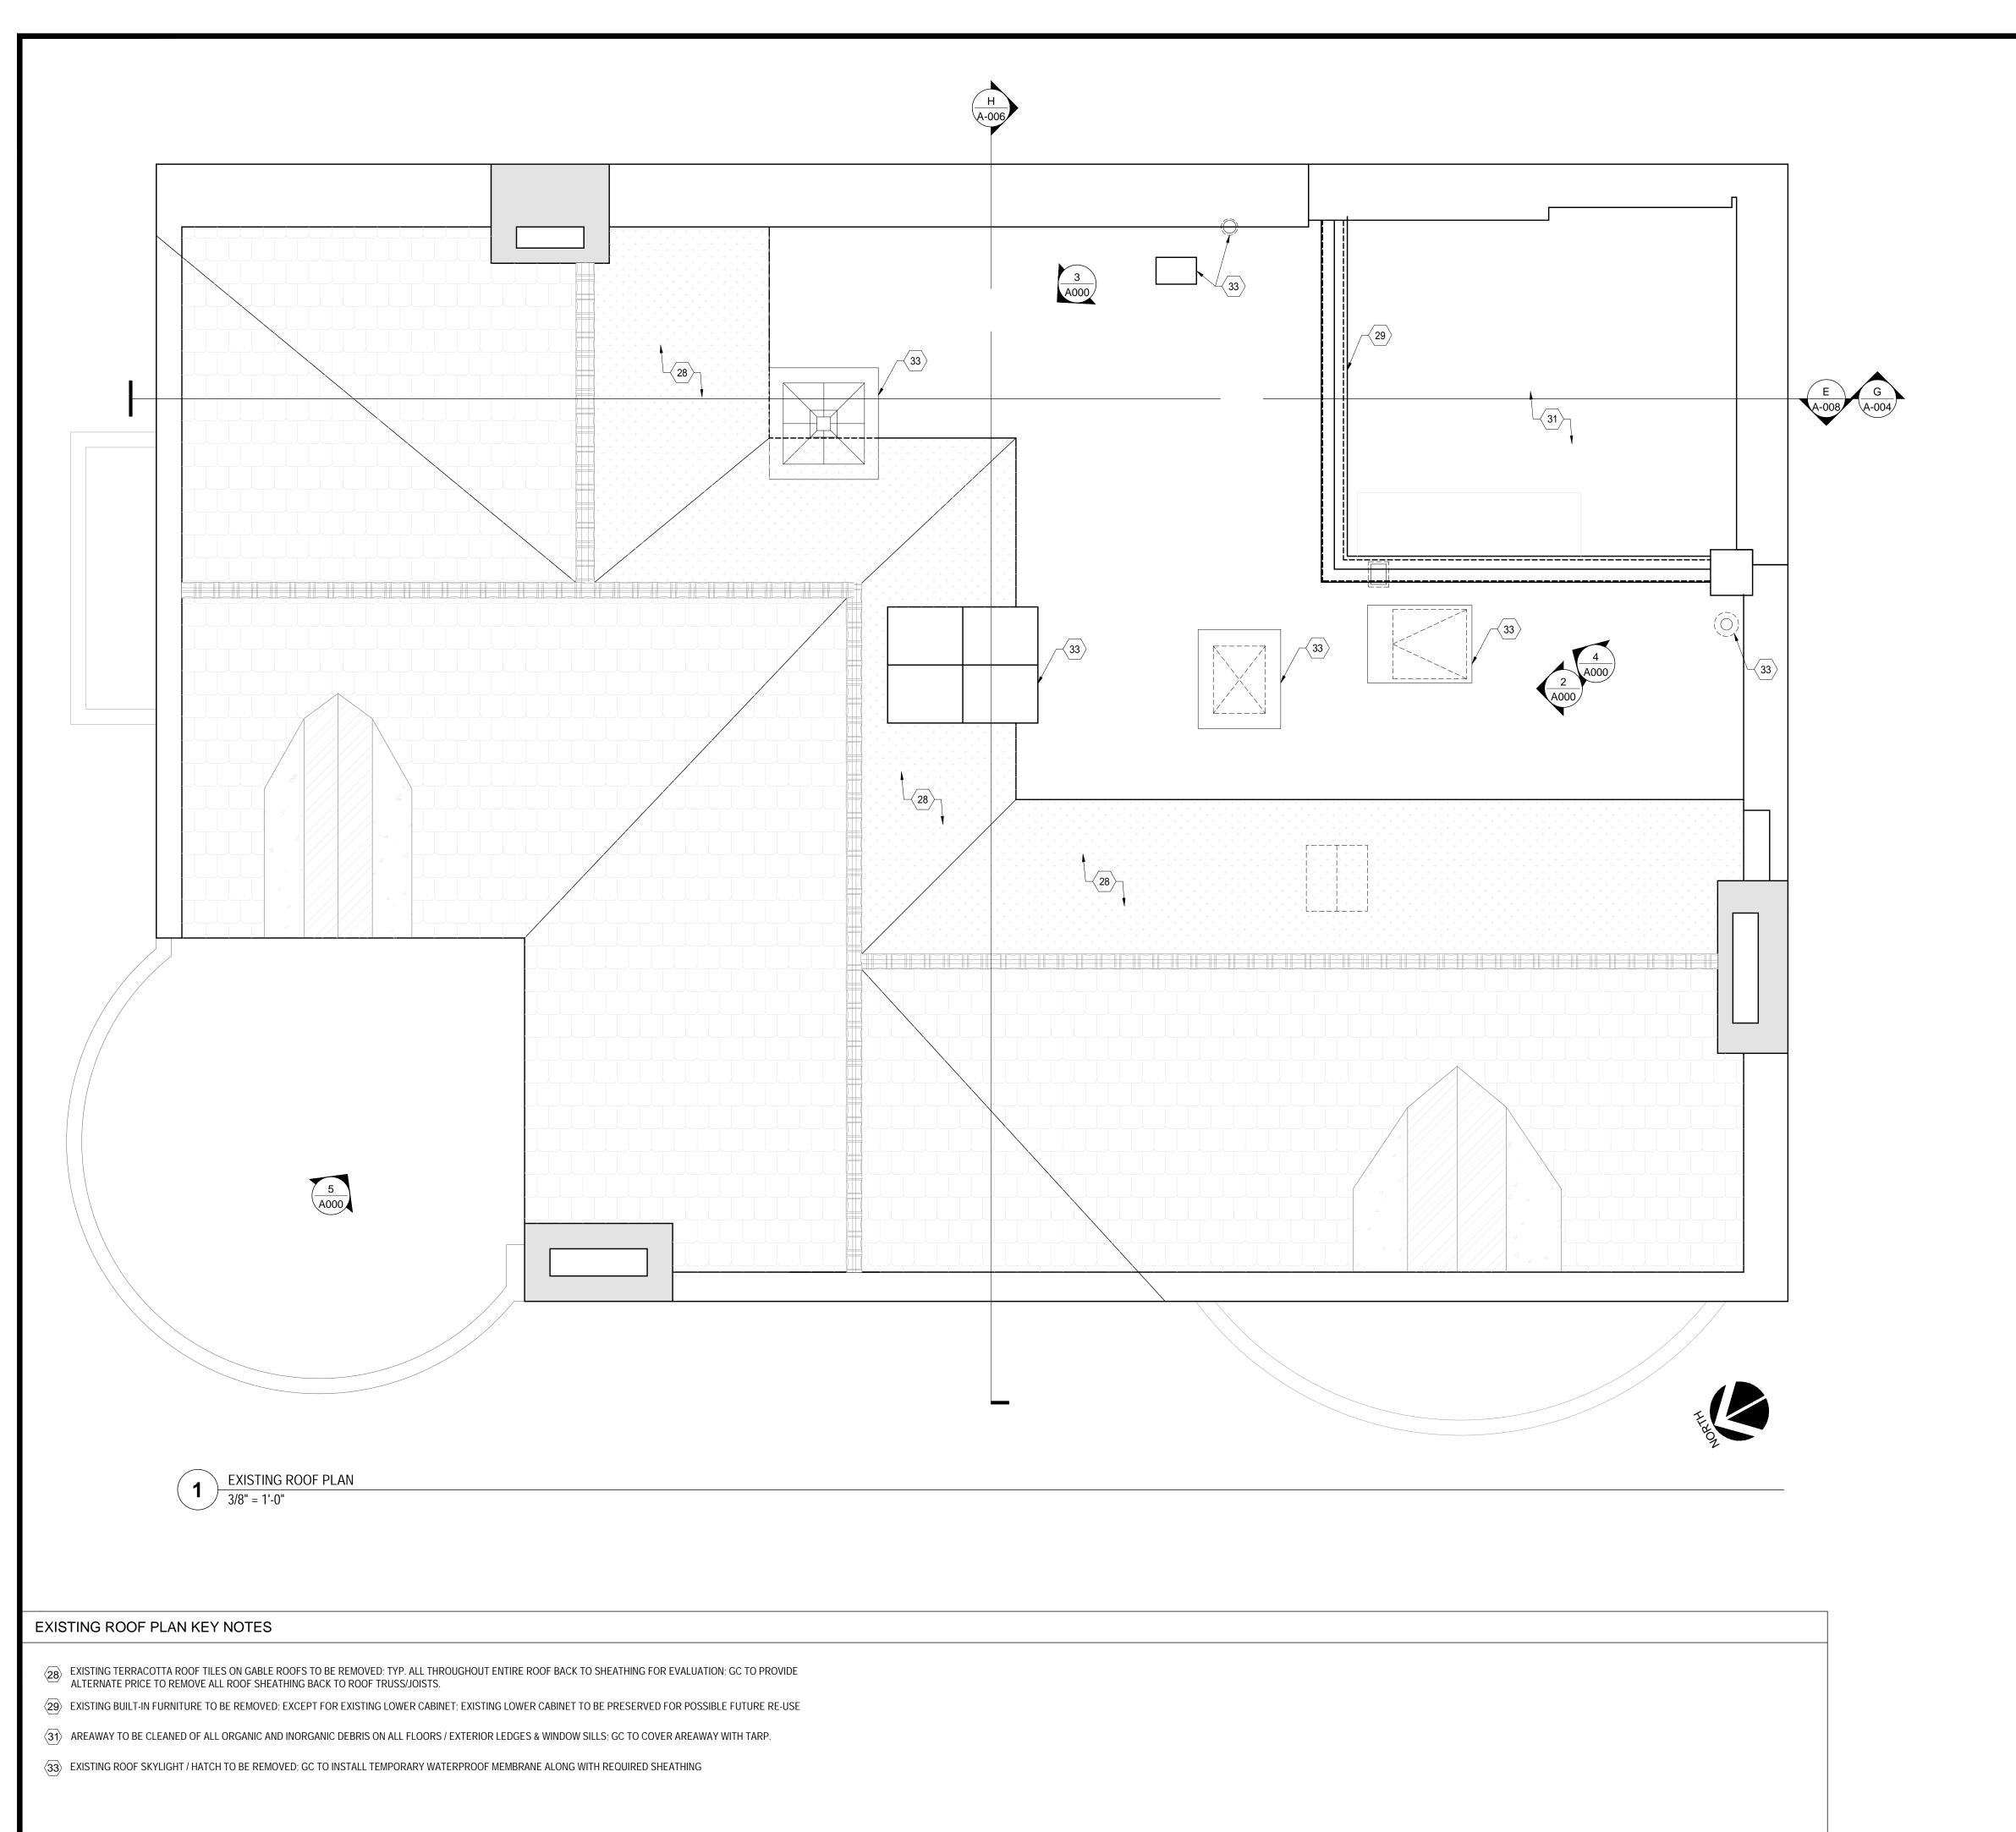
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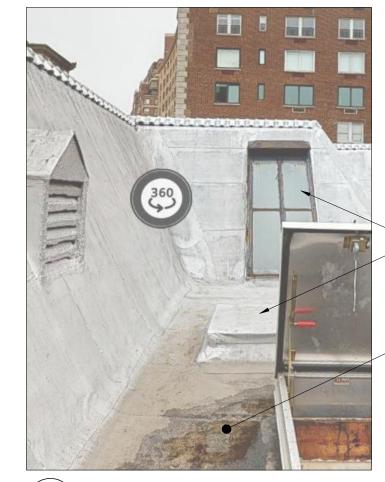
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ROOF STREET VIEW PHOTOS BLOW UP








> EXISTING SKYLIGHTS AND ASSOCIATED CURBS TO BE REMOVED; TYP. ALL THROUGHOUT ROOF

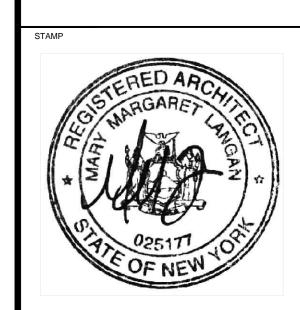EXISTING TAR MATERIAL
THROUGHOUT ROOF CONTAINS
ASBESTOS MATERIAL TO BE
REMOVED; SHOWN HATCHED; CONFIRM EXTENTS ON SITE; REFERENCE ASBESTOS SURVEY REPORT & TESTING FOR ADDITIONAL INFORMATION


ROOF PICTURE

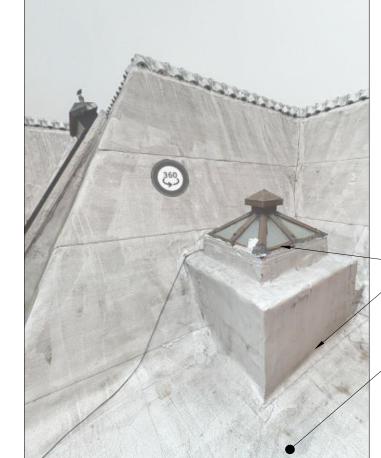

EXISTING SKYLIGHTS AND ASSOCIATED CURBS TO BE REMOVED; TYP. ALL THROUGHOUT ROOF

EXISTING TAR MATERIAL
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FOR ADDITIONAL INFORMATION

ROOF PICTURE

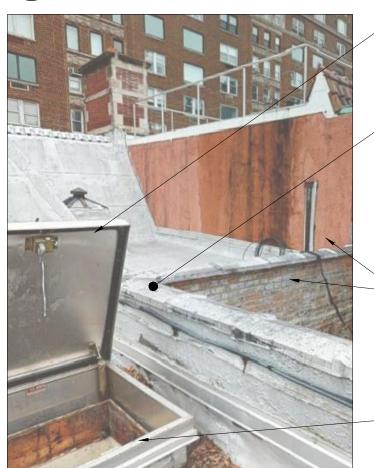

EXISTING SKYLIGHTS AND ASSOCIATED CURBS TO BE REMOVED; TYP. ALL THROUGHOUT ROOF

EXISTING TAR MATERIAL THROUGHOUT ROOF CONTAINS ASBESTOS MATERIAL TO BE REMOVED; SHOWN HATCHED; CONFIRM EXTENTS ON SITE; REFERENCE ASBESTOS SURVEY REPORT & TESTING FOR ADDITIONAL INFORMATION

EXISTING VENT LINES AND UTILITIES TO BE REMOVED

EXISTING HATCH AND ASSOCIATED CURBS TO BE REMOVED

ROOF PICTURE



O'NEIL LANGAN ARCHITECTS


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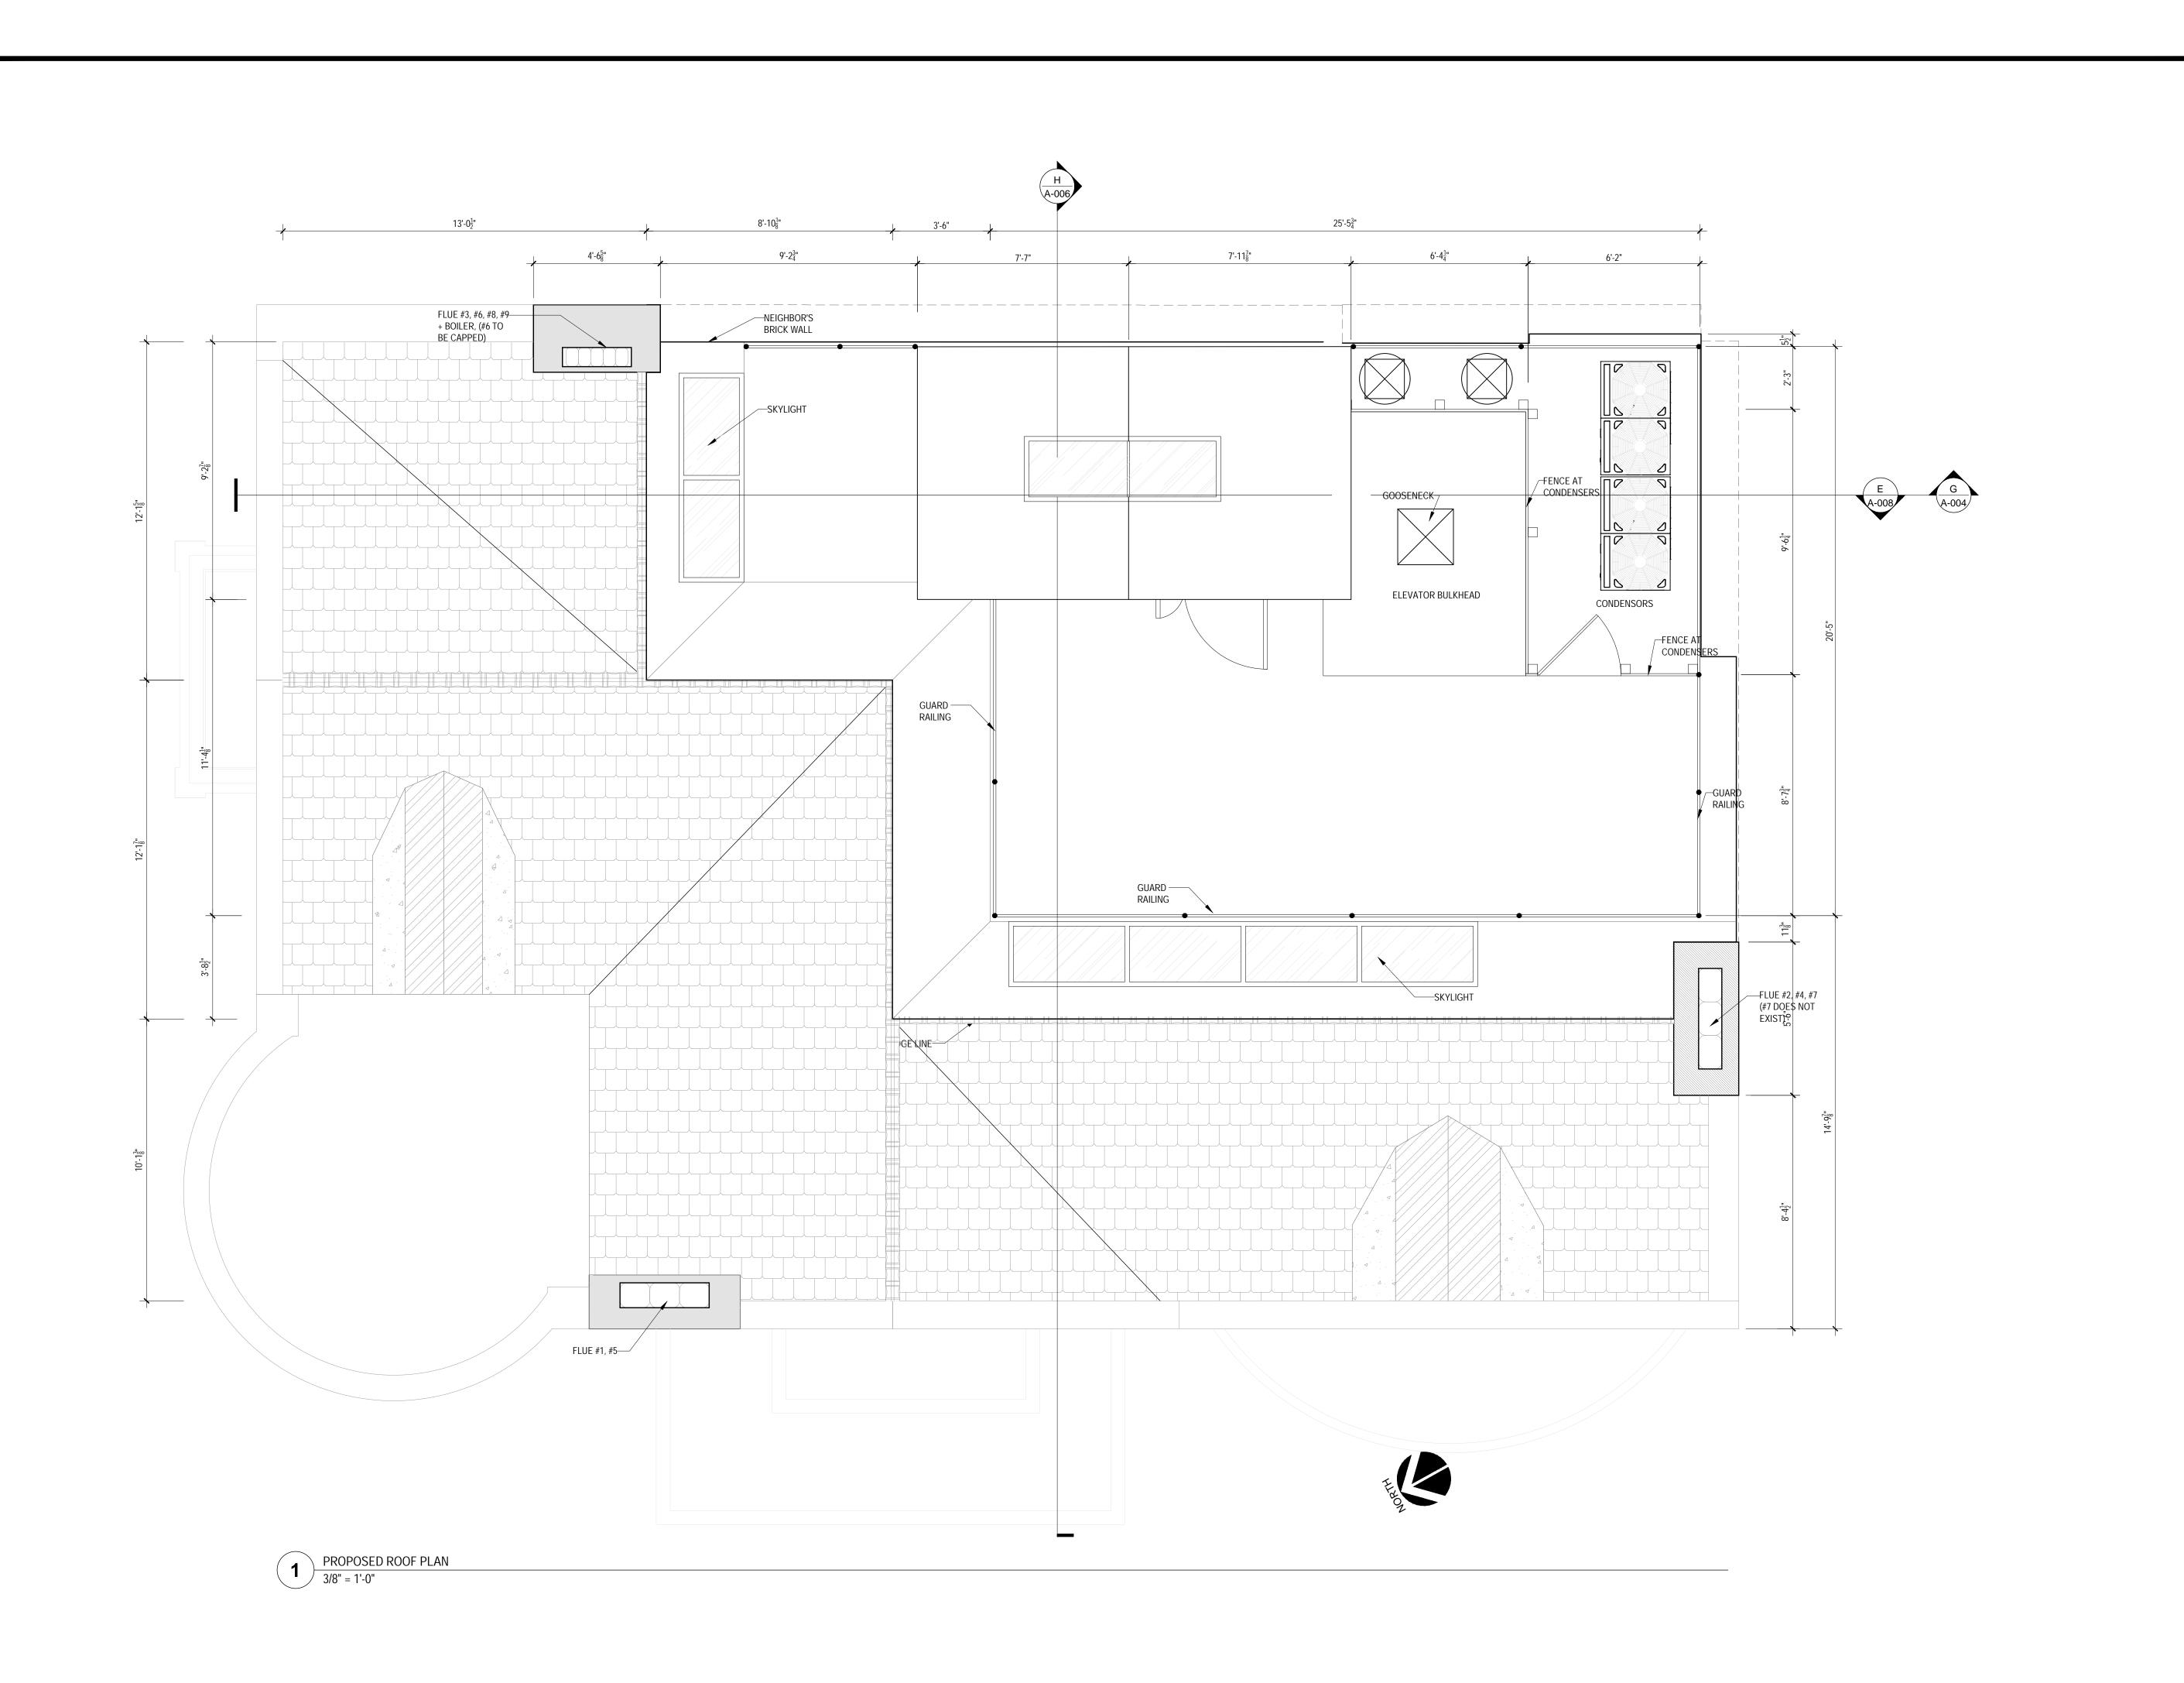
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PRC	DJECT NO.: 221163		
DAT	E: 06.01.2021		
DRA	WN BY: MH		
CHECKED BY: SC / ML			
ARE	A: 9698 SQ FT		
#	ISSUE	DATE	
	FOR LPC AND PERMIT	06/17/2	
	EOD LDC AND DEDMIT	07/20/2	

FOR LPC AND PERMIT FOR COMMUNITY BOARD HEARING 08/05/20 FOR COMMUNITY BOARD HEARING | 08/11/20 SHEET TITLE

EXISTING ROOF PLANS & **ROOF PHOTOS**



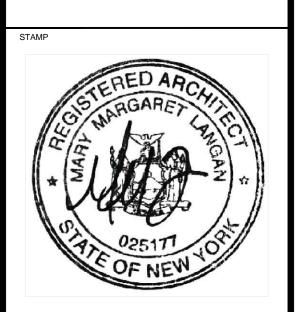

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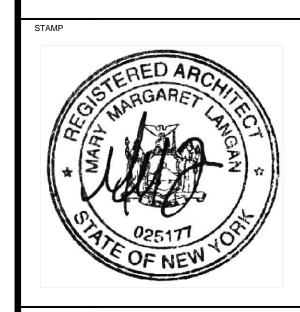
MEP ENGINEER

STRUCTURAL ENGINEER

Christie Engineering, P.C.

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DATE: 06.01.2021		
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AREA: 9698 SQ F	Т	
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#	ISSUE	DATE
	FOR LPC AND PERMIT	06/17/20
	FOR LPC AND PERMIT	07/29/20
	FOR COMMUNITY BOARD HEARING	08/05/20
	FOR COMMUNITY BOARD HEARING	08/11/20
	FOR LPC AND PERMIT	09/09/20

PROPOSED ROOF PLANS & BUILDING MODEL



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STRUCTURAL ENGINEER

Christie Engineering, P.C.

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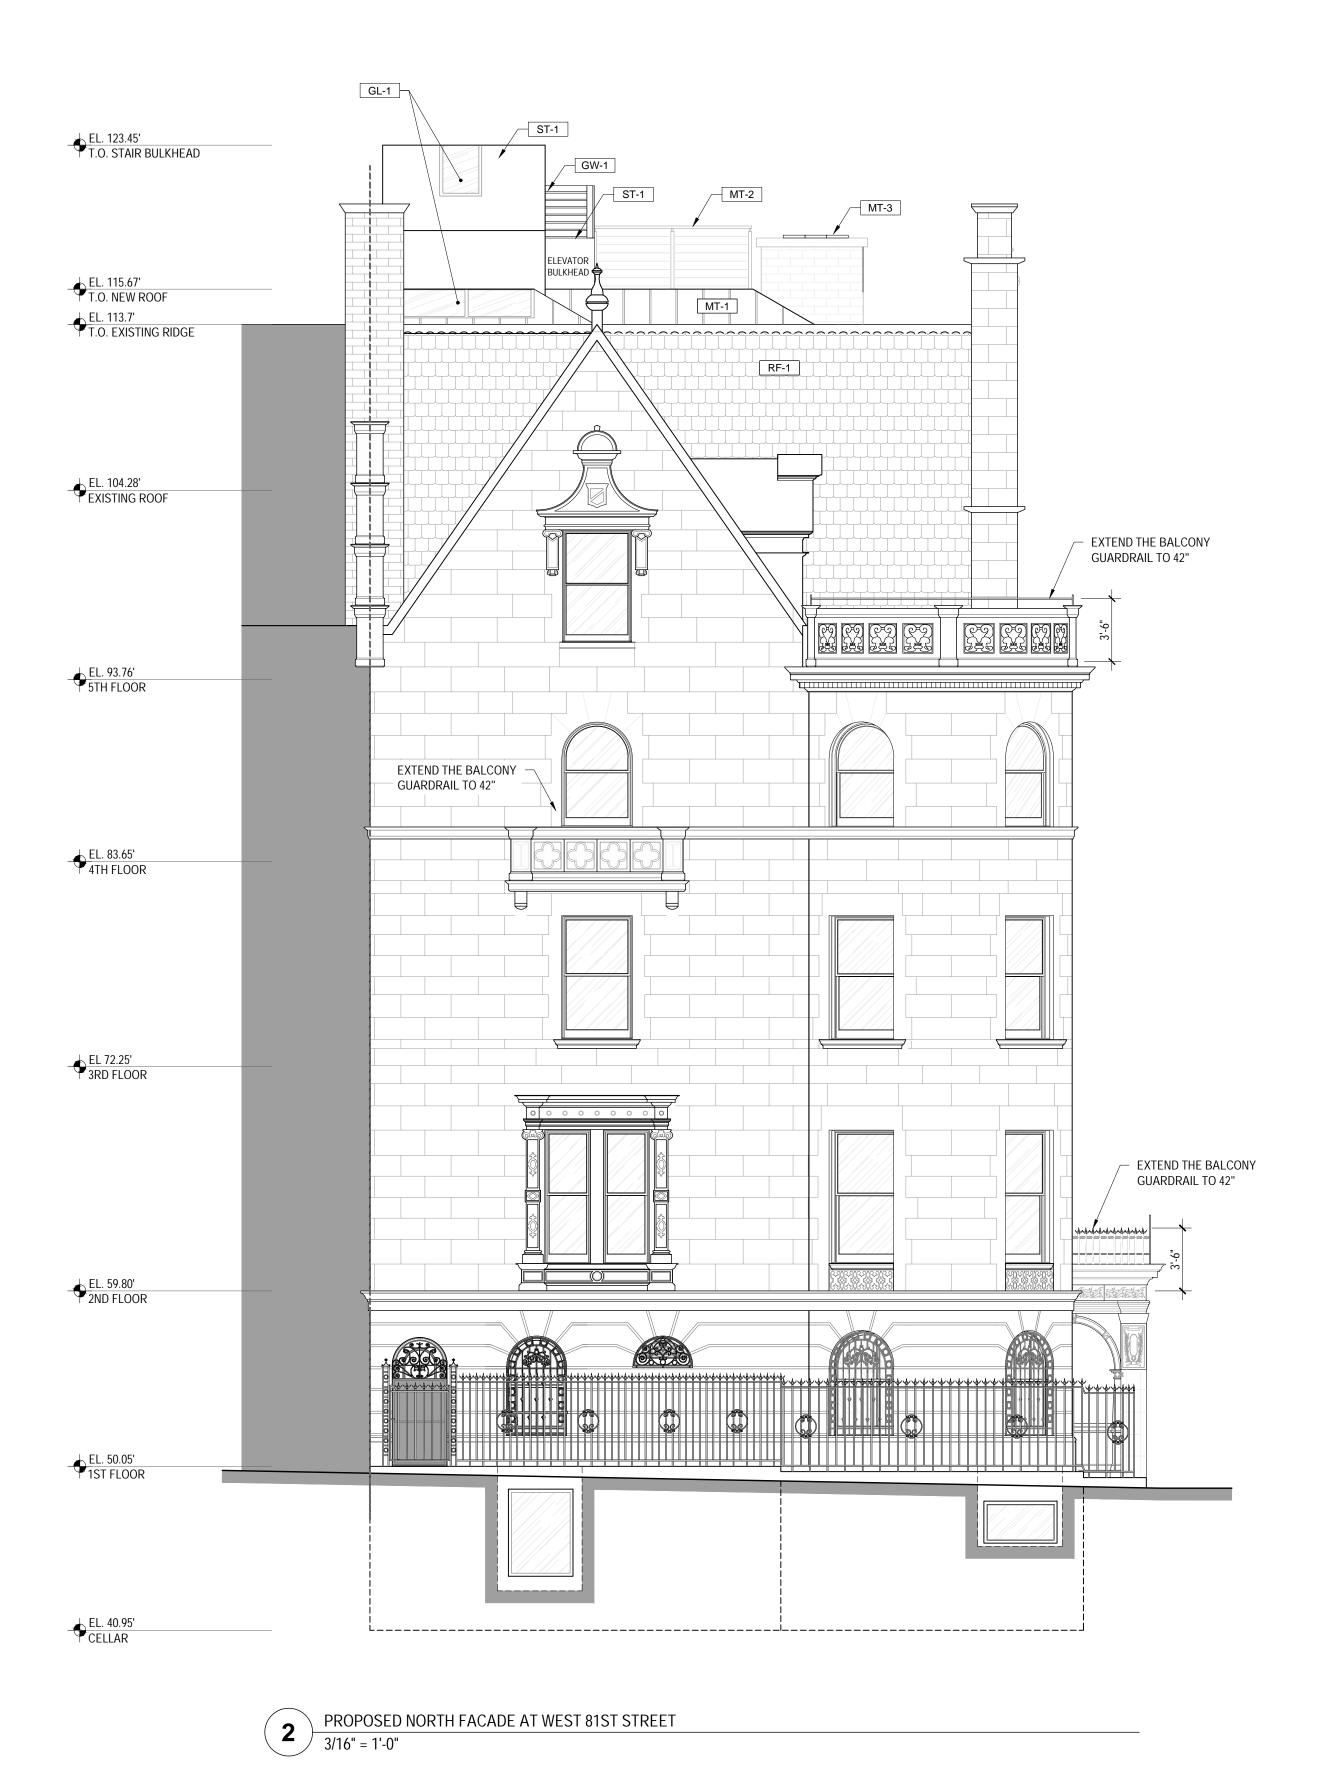
ISSUE DATE FOR LPC AND PERMIT 06/17/202 FOR LPC AND PERMIT FOR COMMUNITY BOARD HEARING 08/05/202 FOR COMMUNITY BOARD HEARING 08/11/202

EXTERIOR ELEVATIONS



EXISTING NORTH FACADE AT WEST 81ST STREET

3/16" = 1'-0"



NOTE: WINDOW RENOVATION PACKAGE TO BE SUBMITTED SEPARATELY

O'NEIL LANGAN
ARCHITECTS

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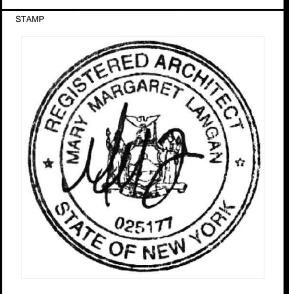
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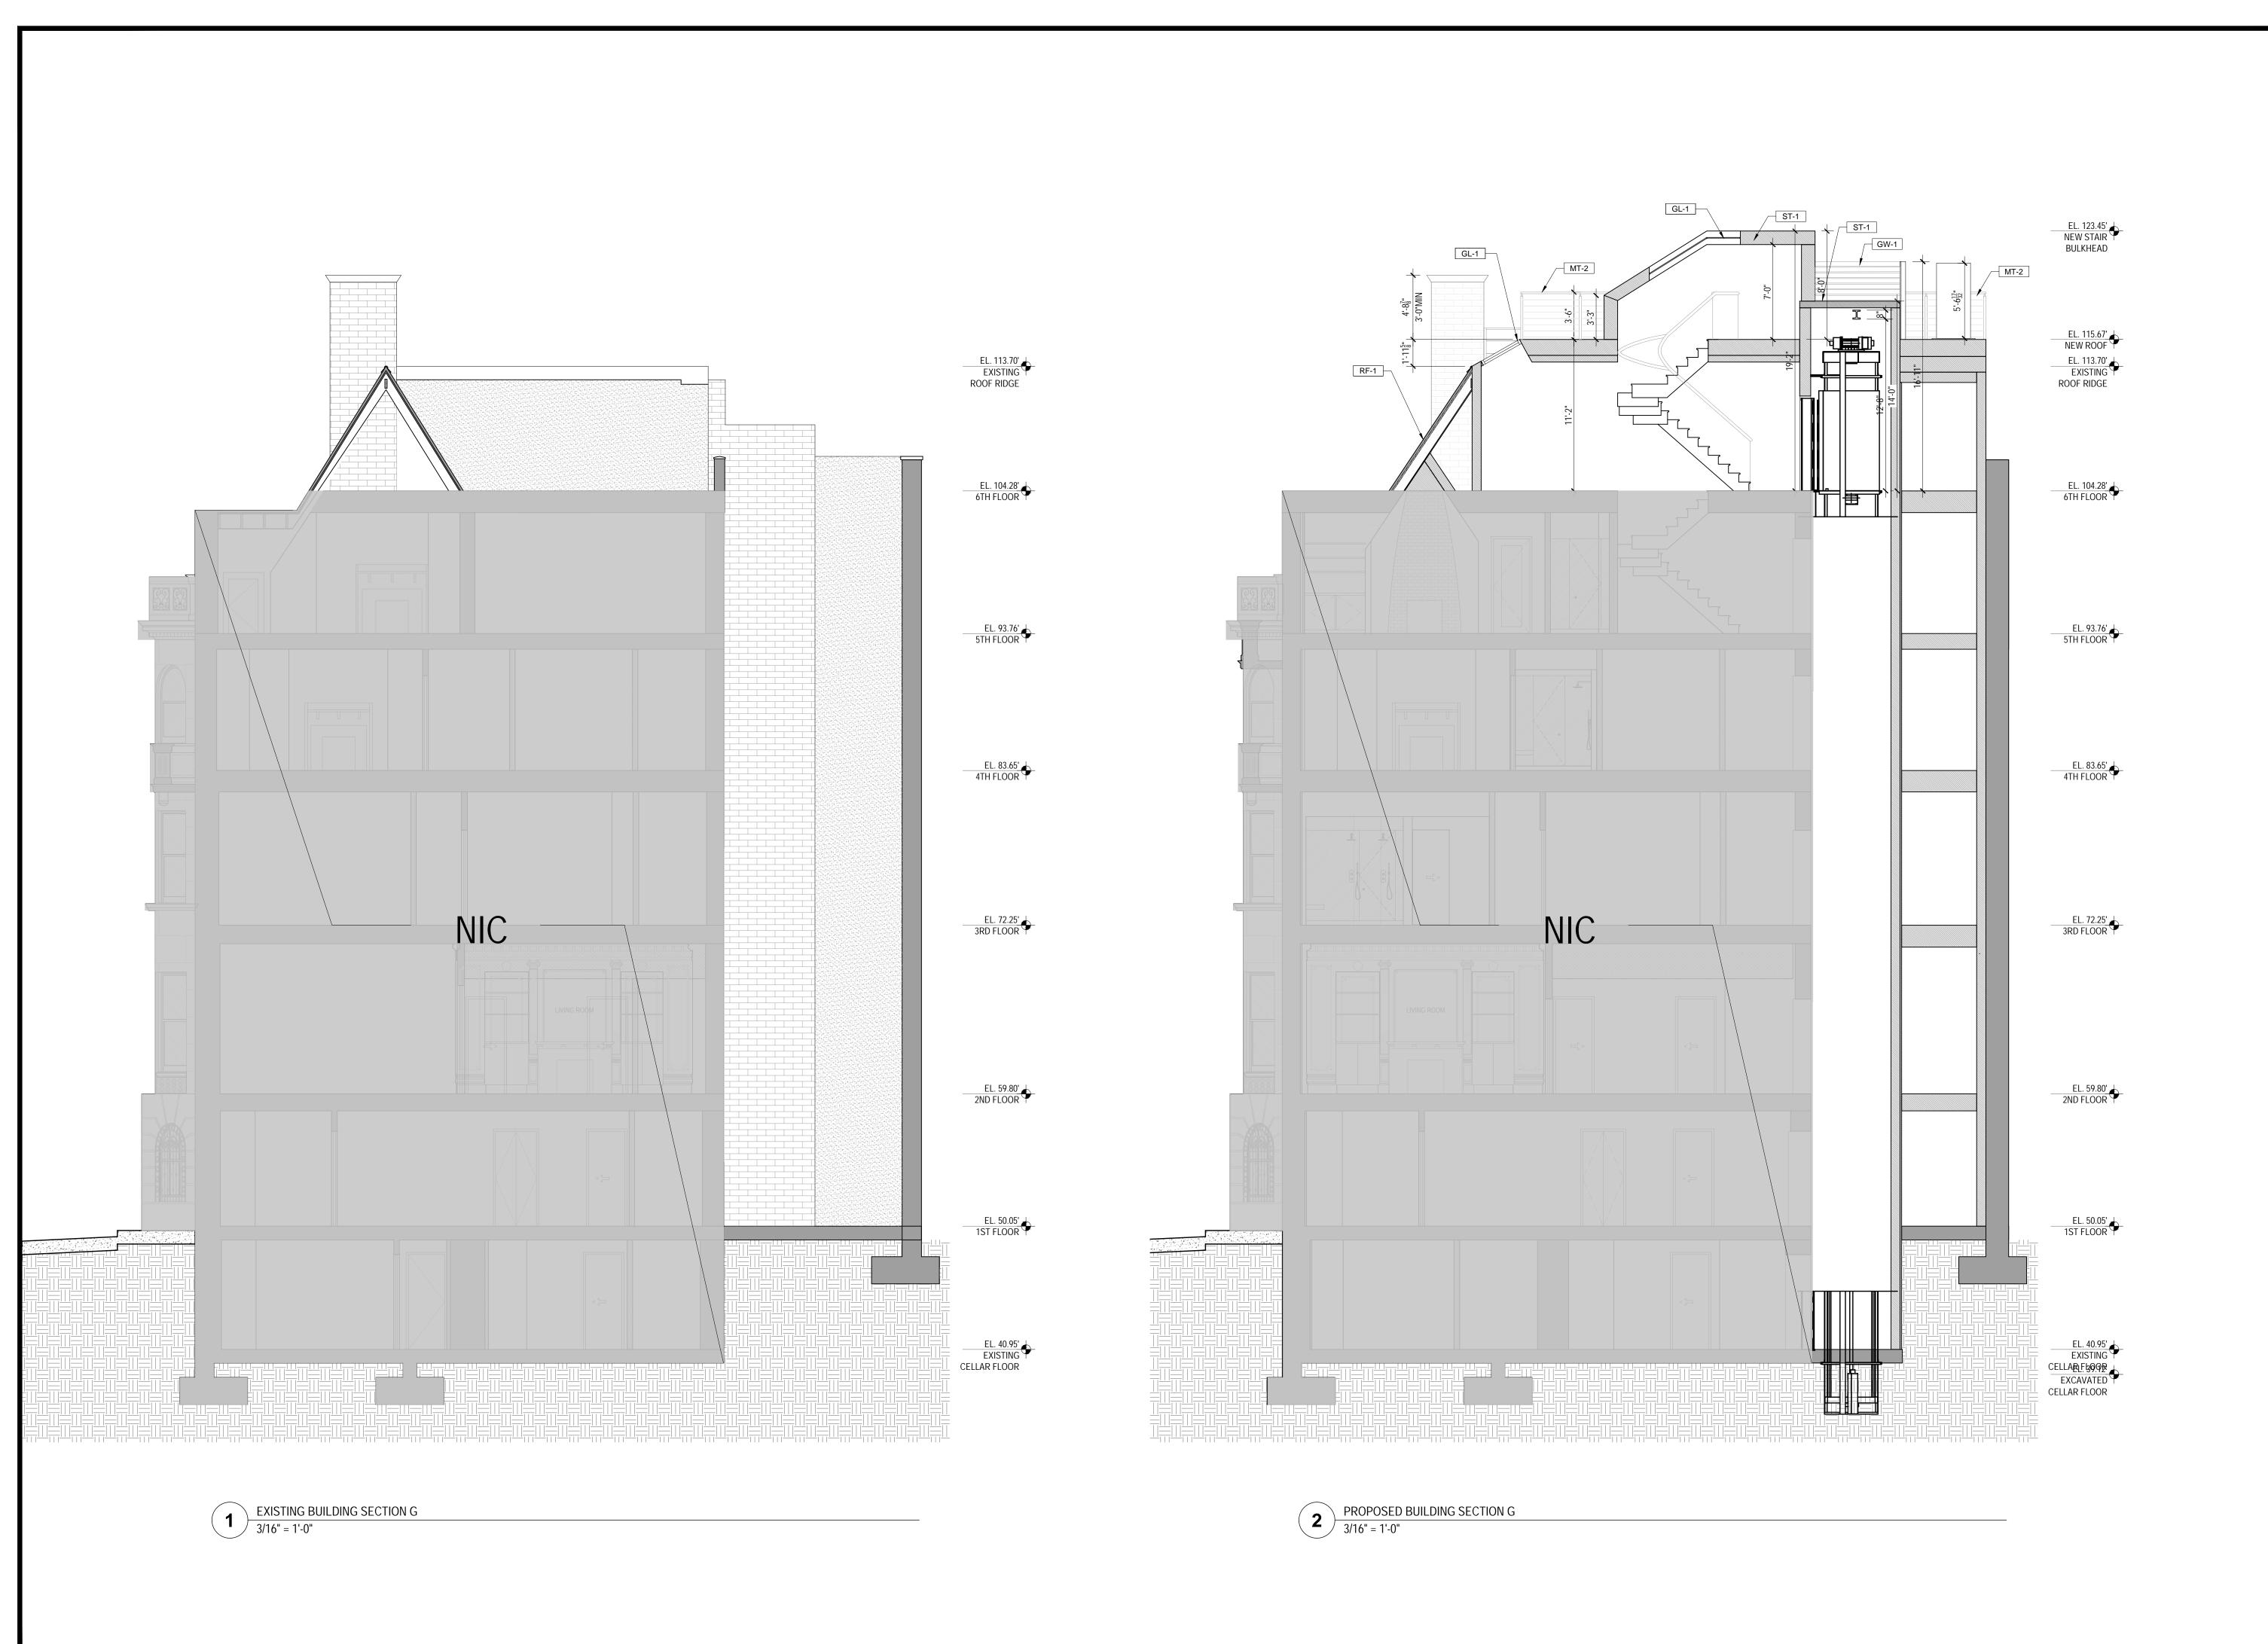
FOR COMMUNITY BOARD HEARING 08/11/202

FOR LPC AND PERMIT 09/09/202

SHEET TITLE

EXTERIOR ELEVATIONS

A-003.00



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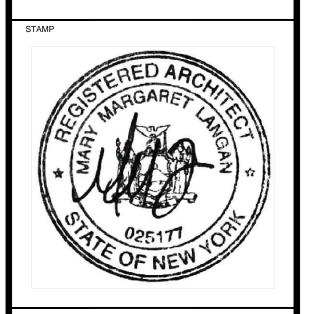
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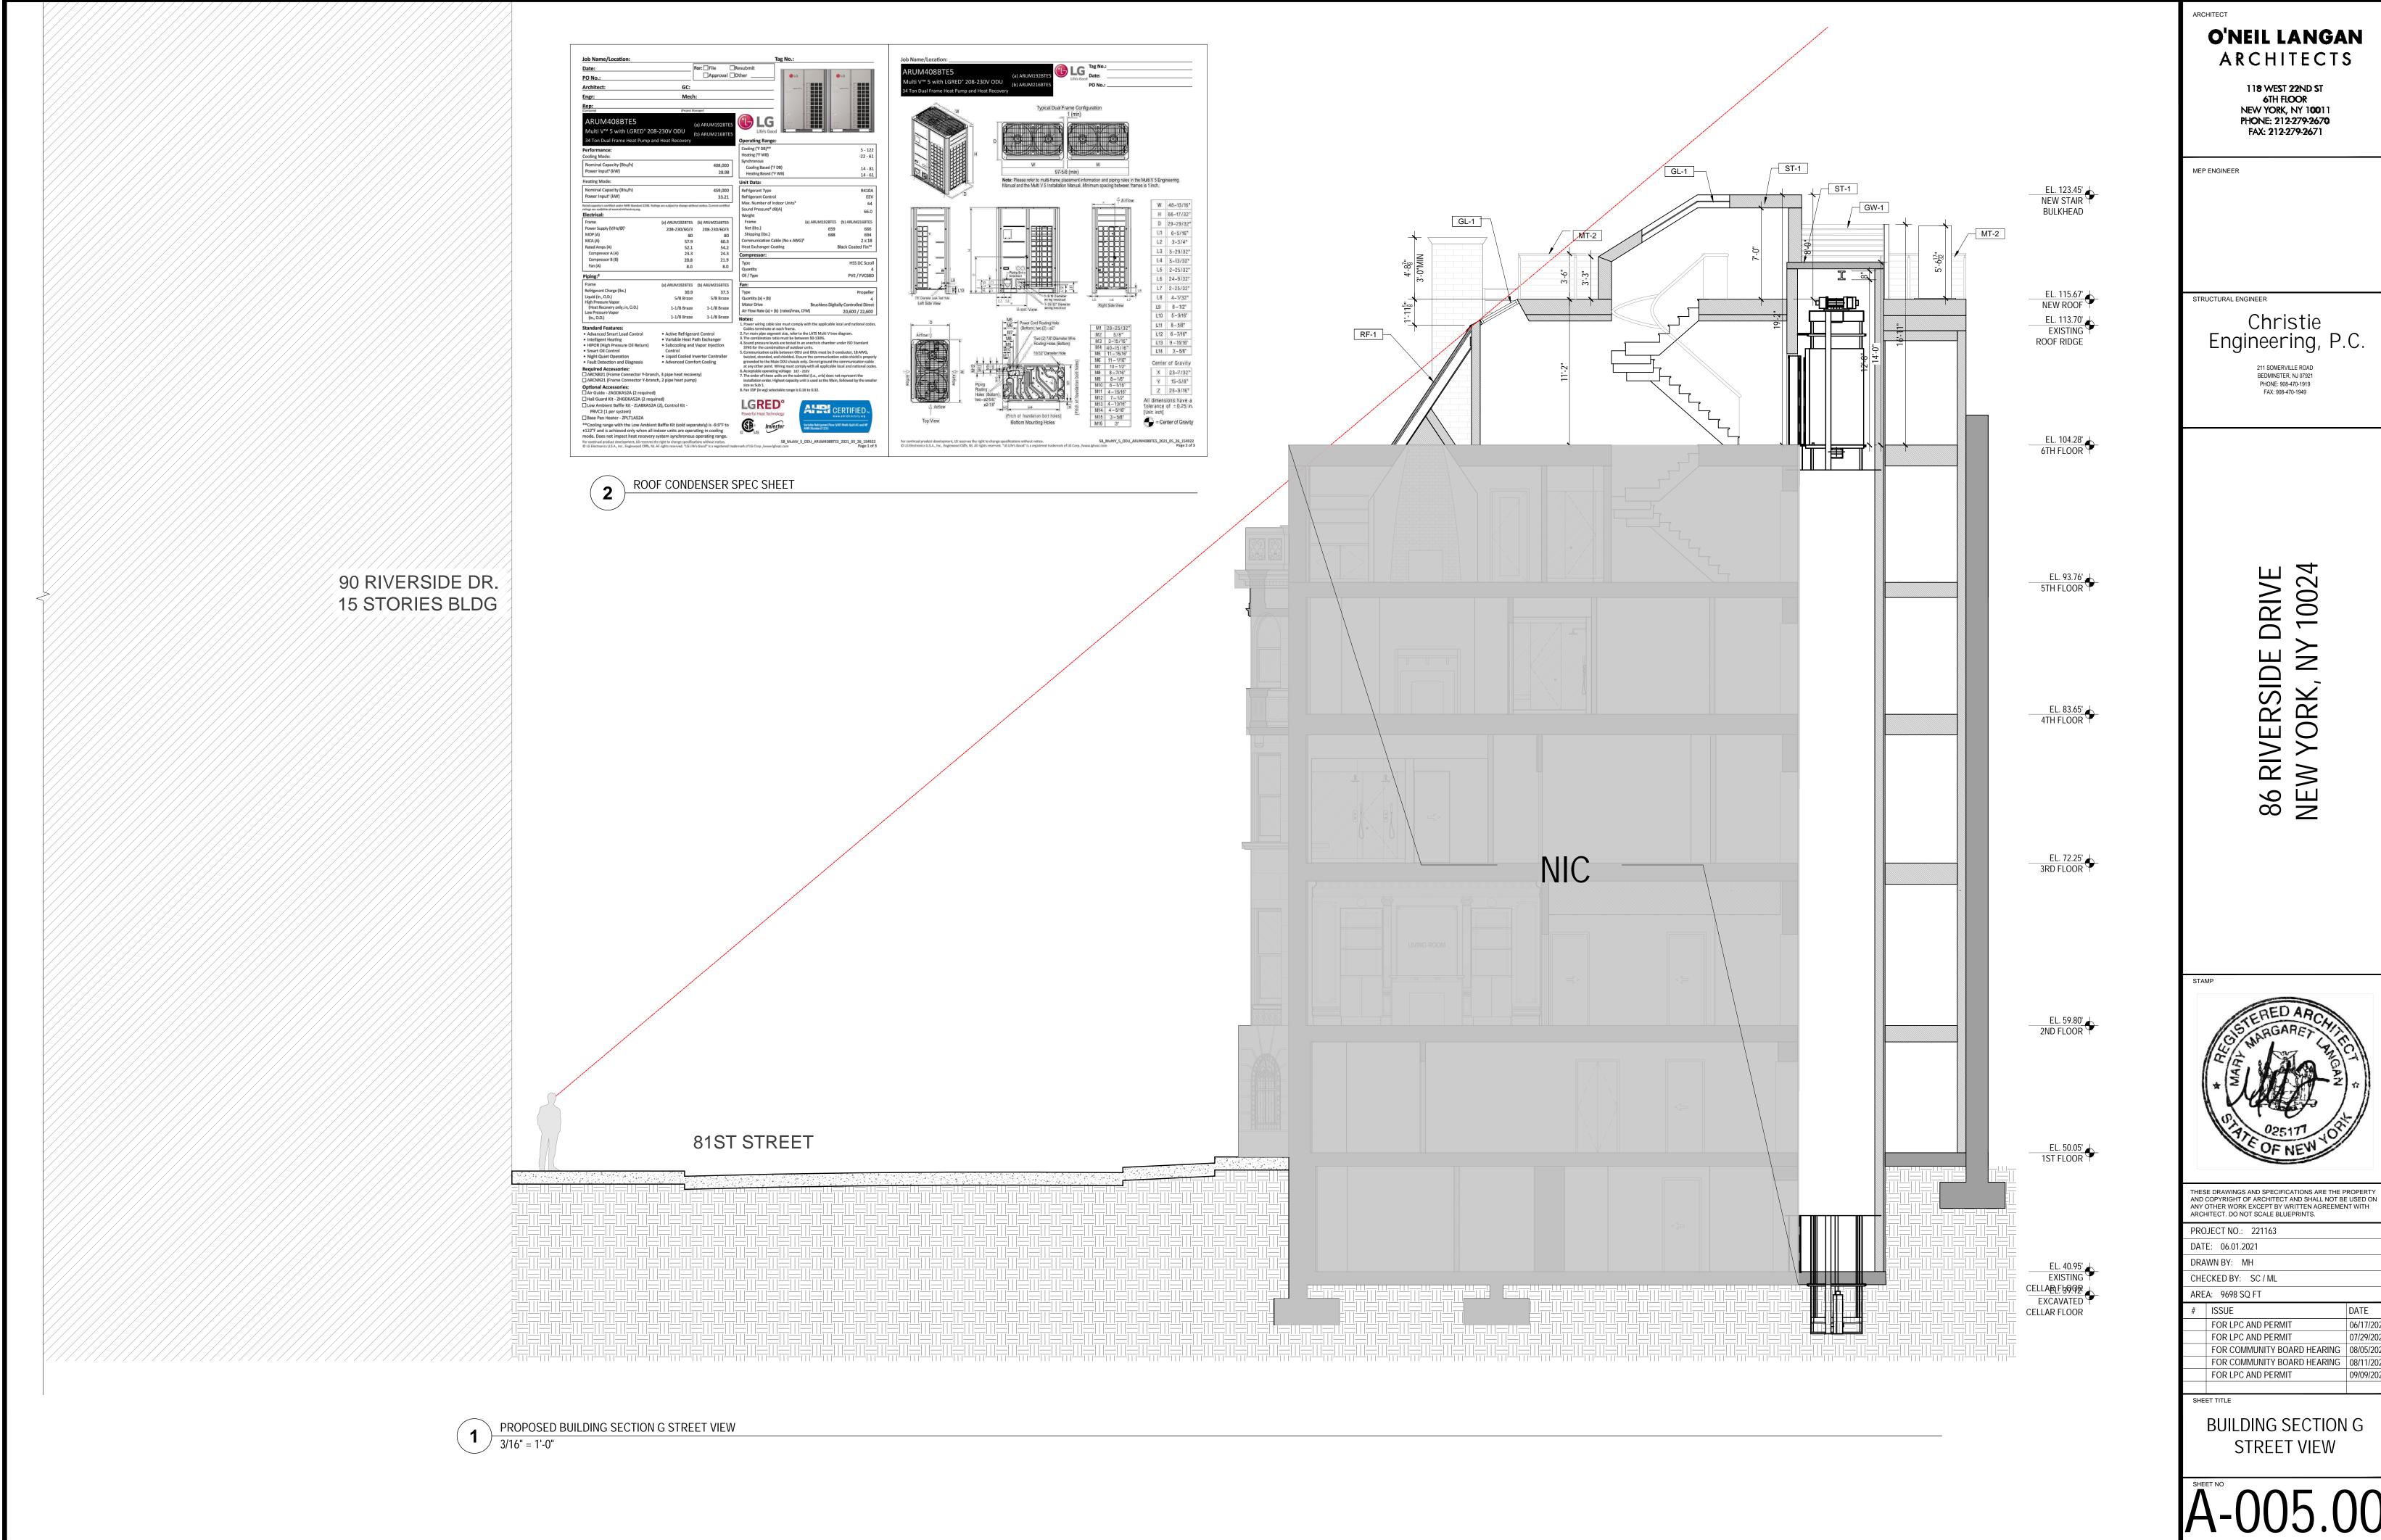
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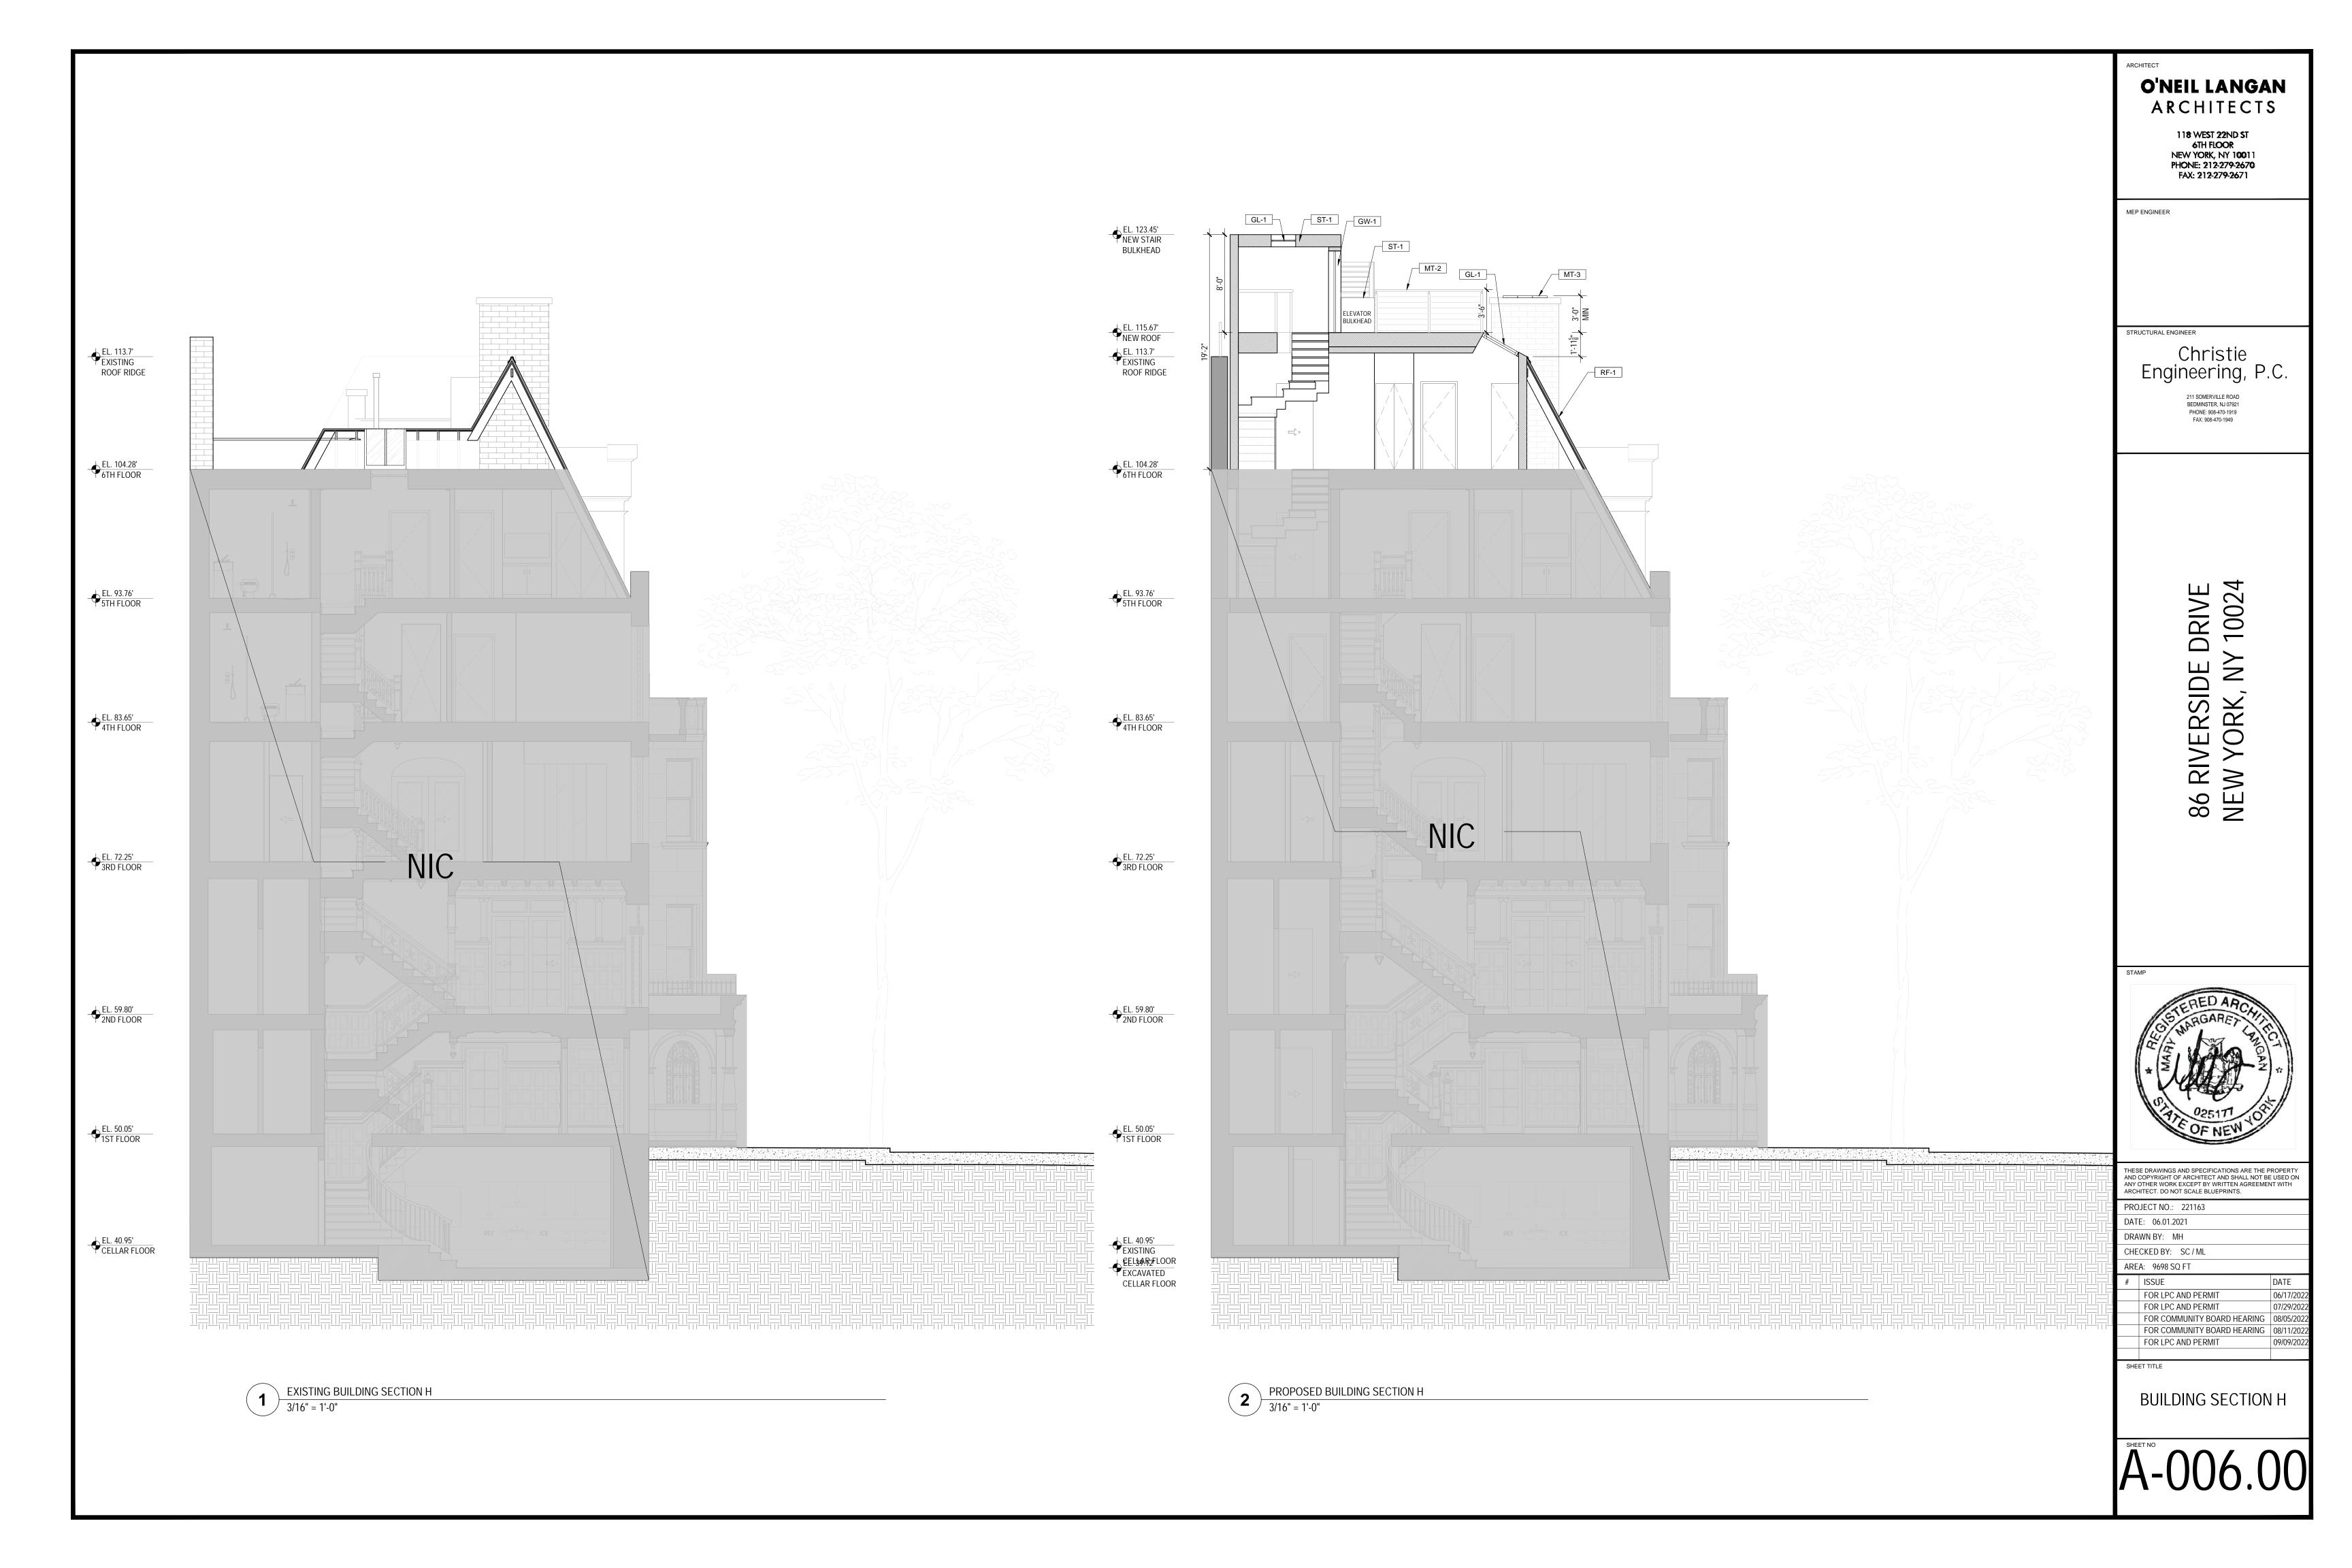
FOR LPC AND PERMIT 09/09/202


SHEET TITLE

BUILDING SECTION G


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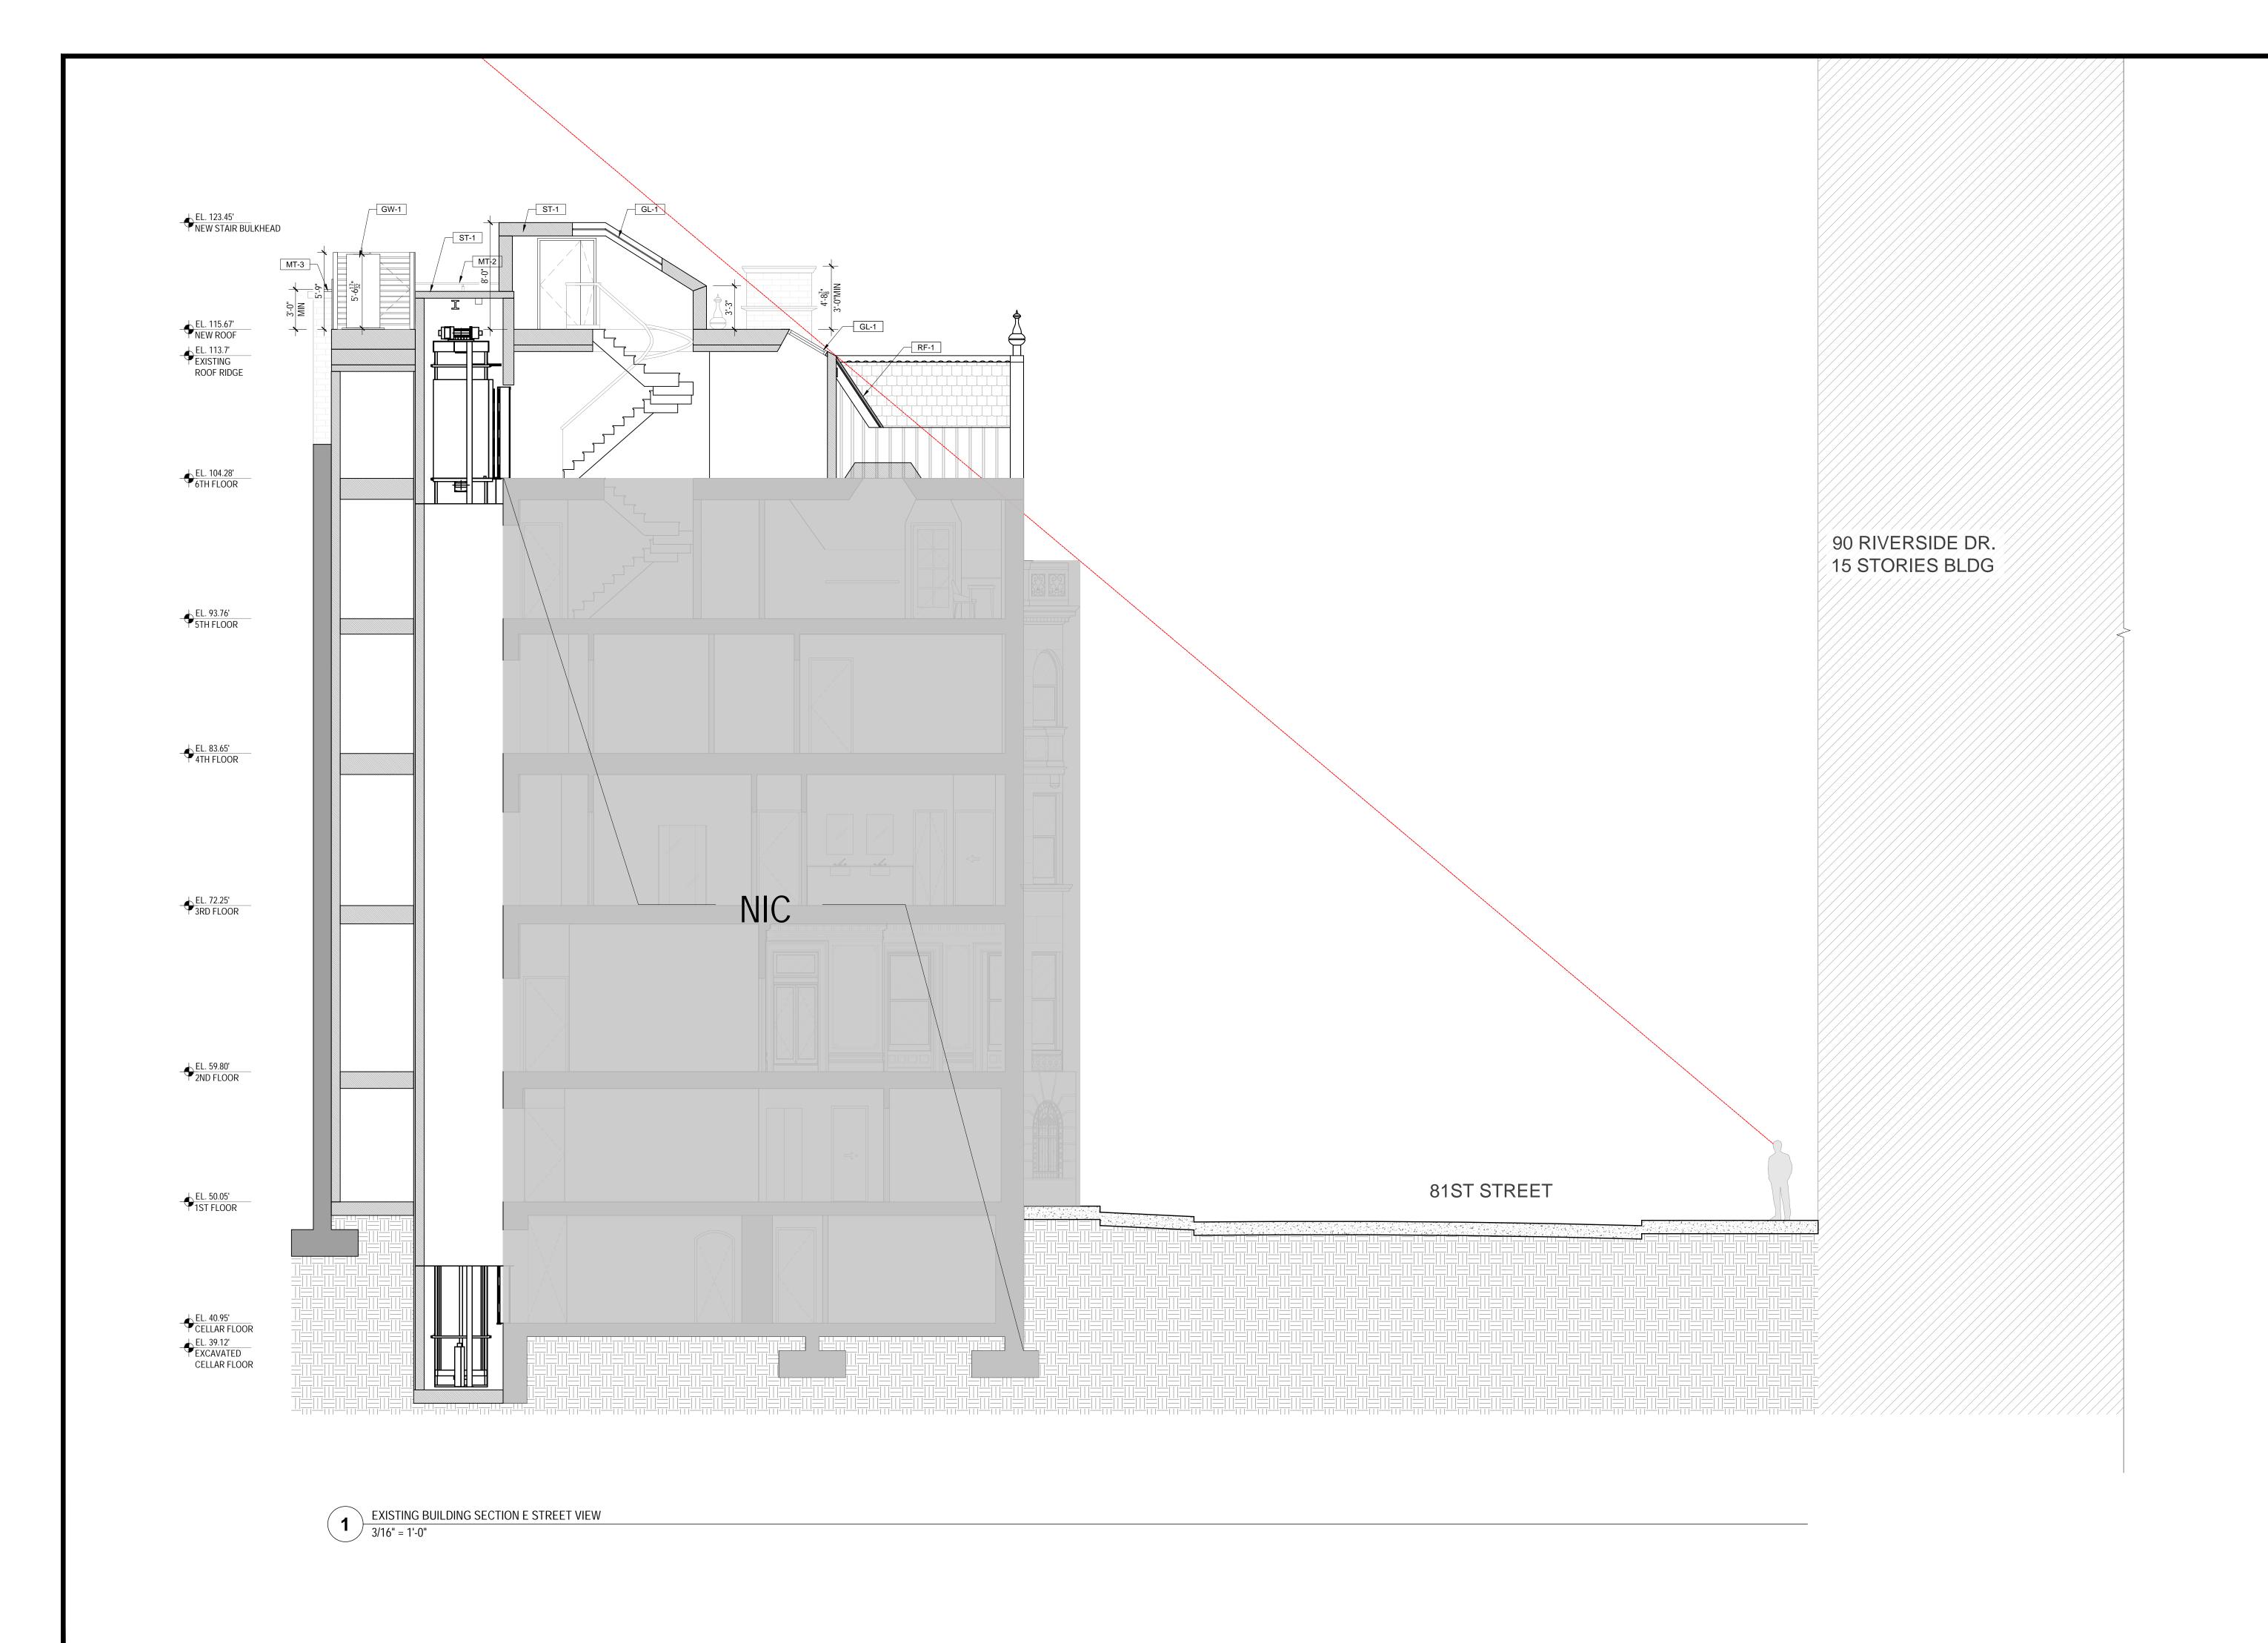






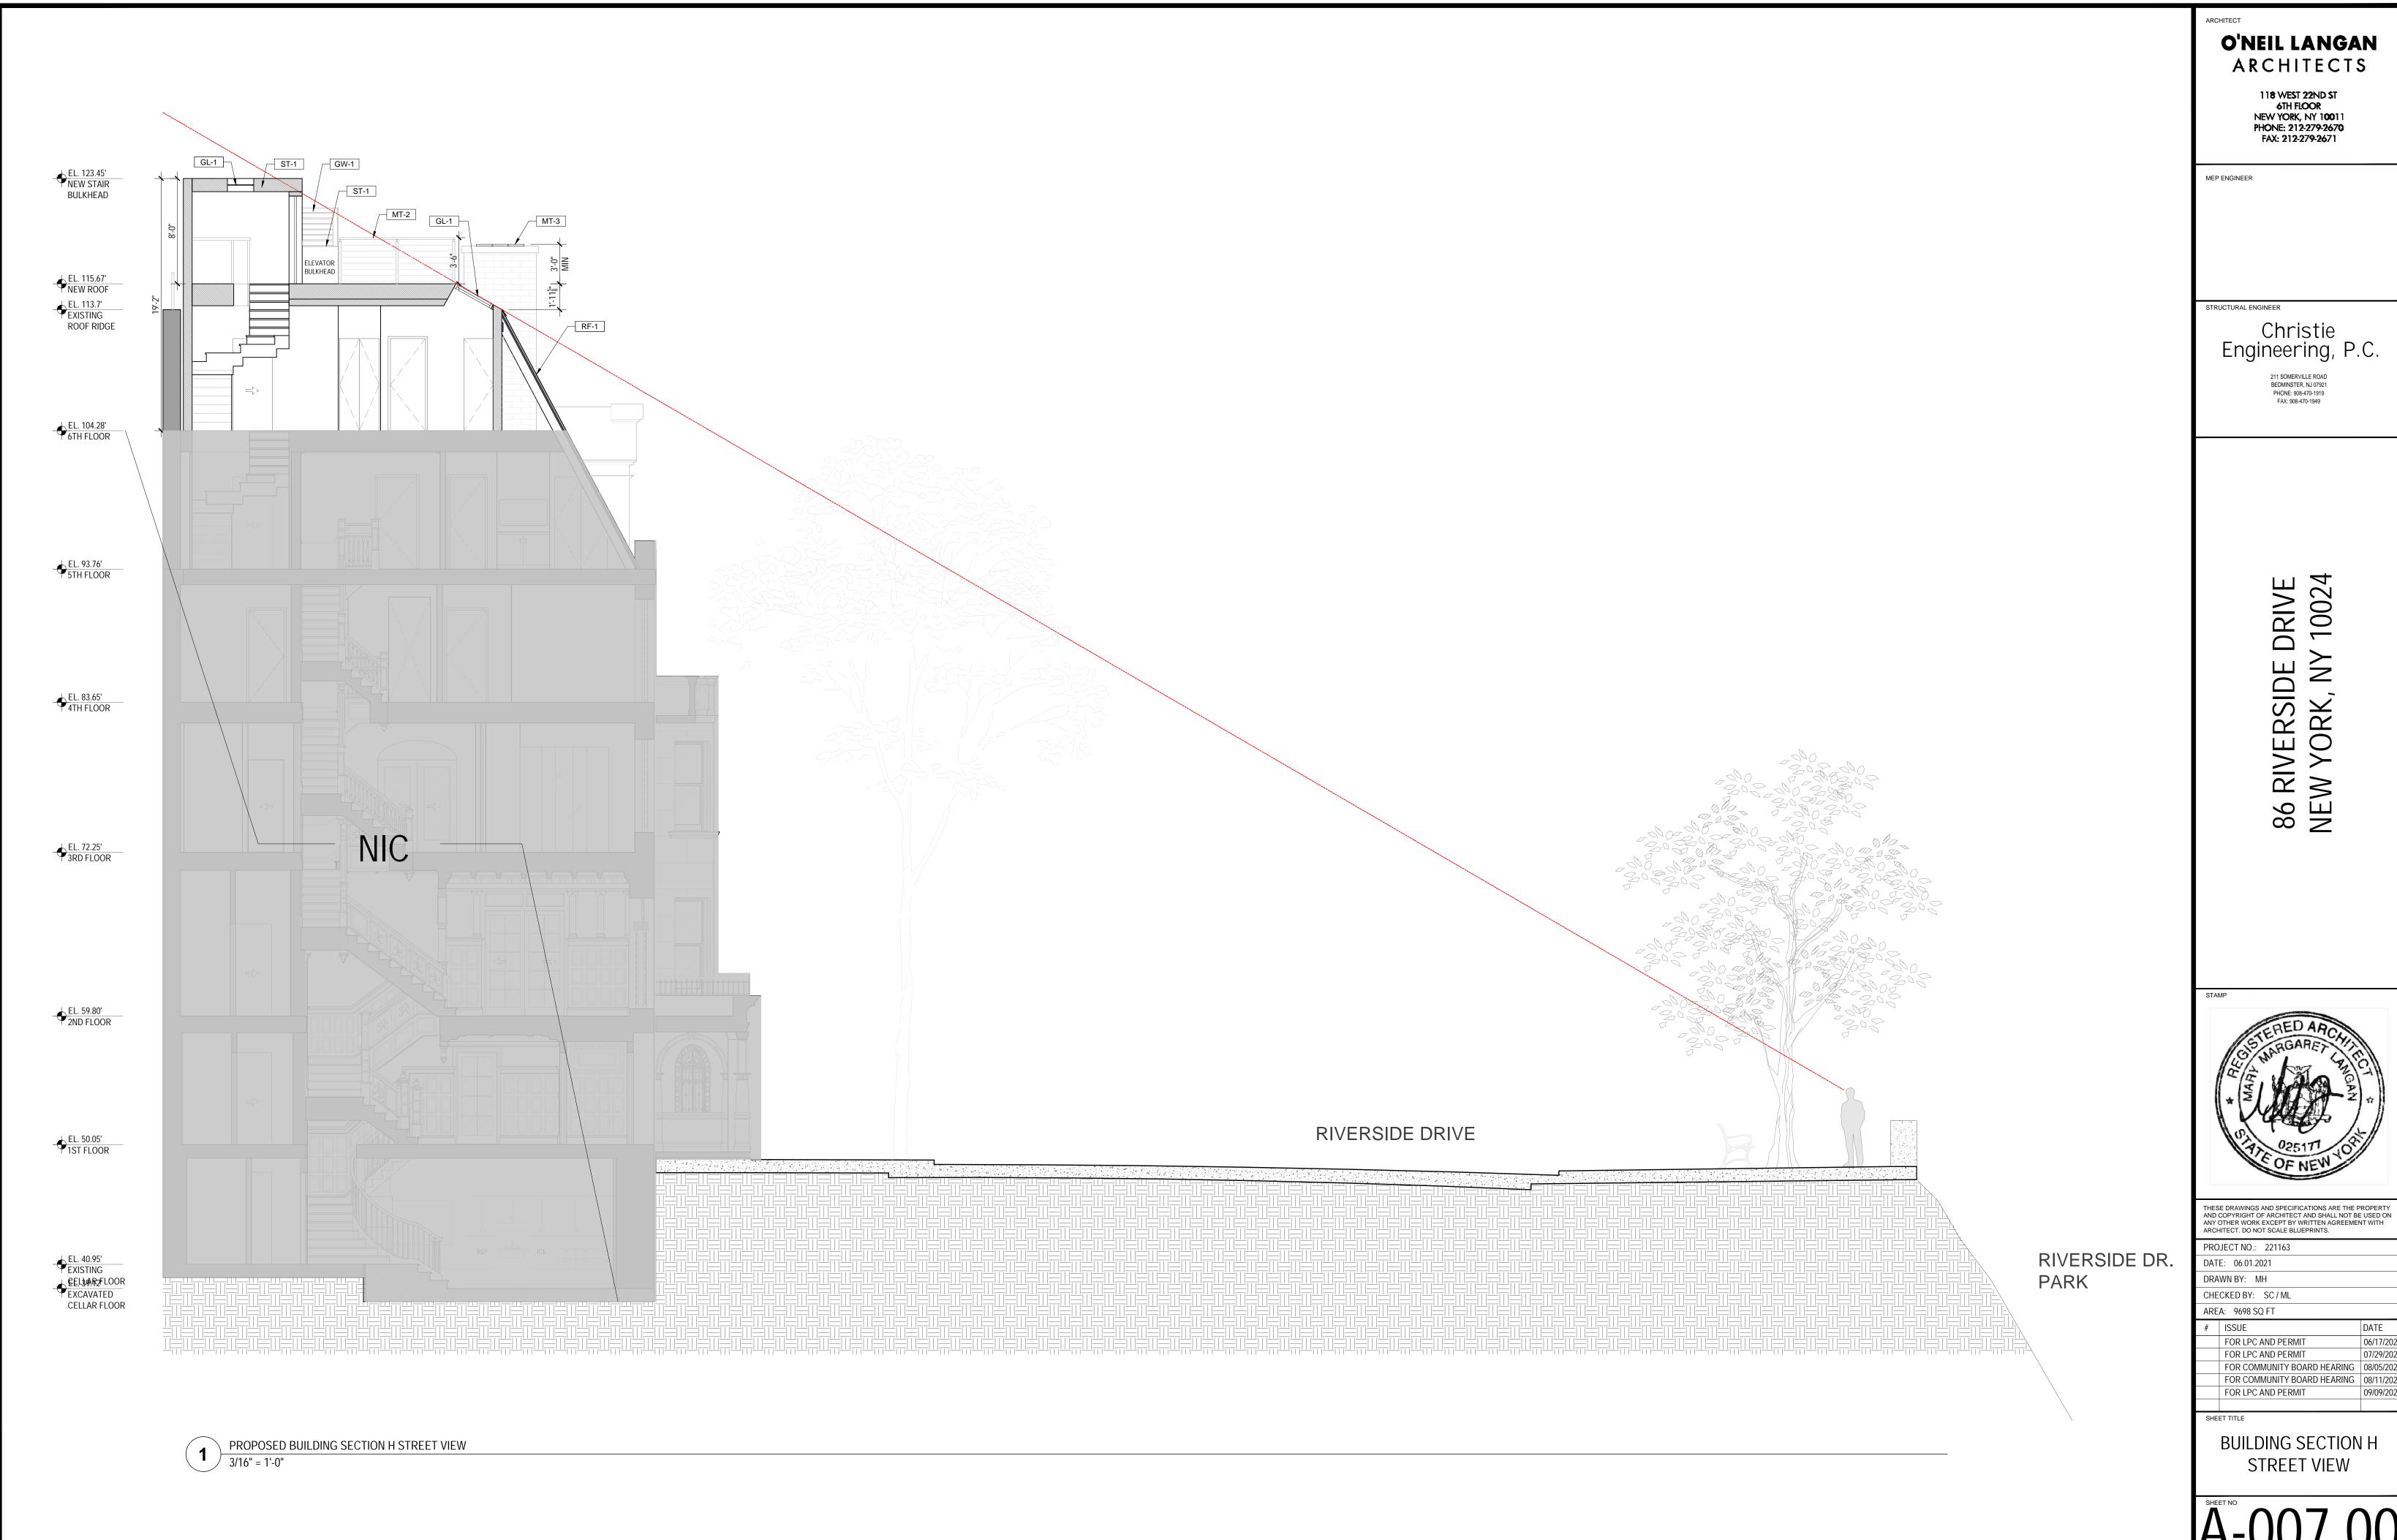

DATE
06/17/202.
07/29/2022 FOR COMMUNITY BOARD HEARING 08/05/202 FOR COMMUNITY BOARD HEARING 08/11/202

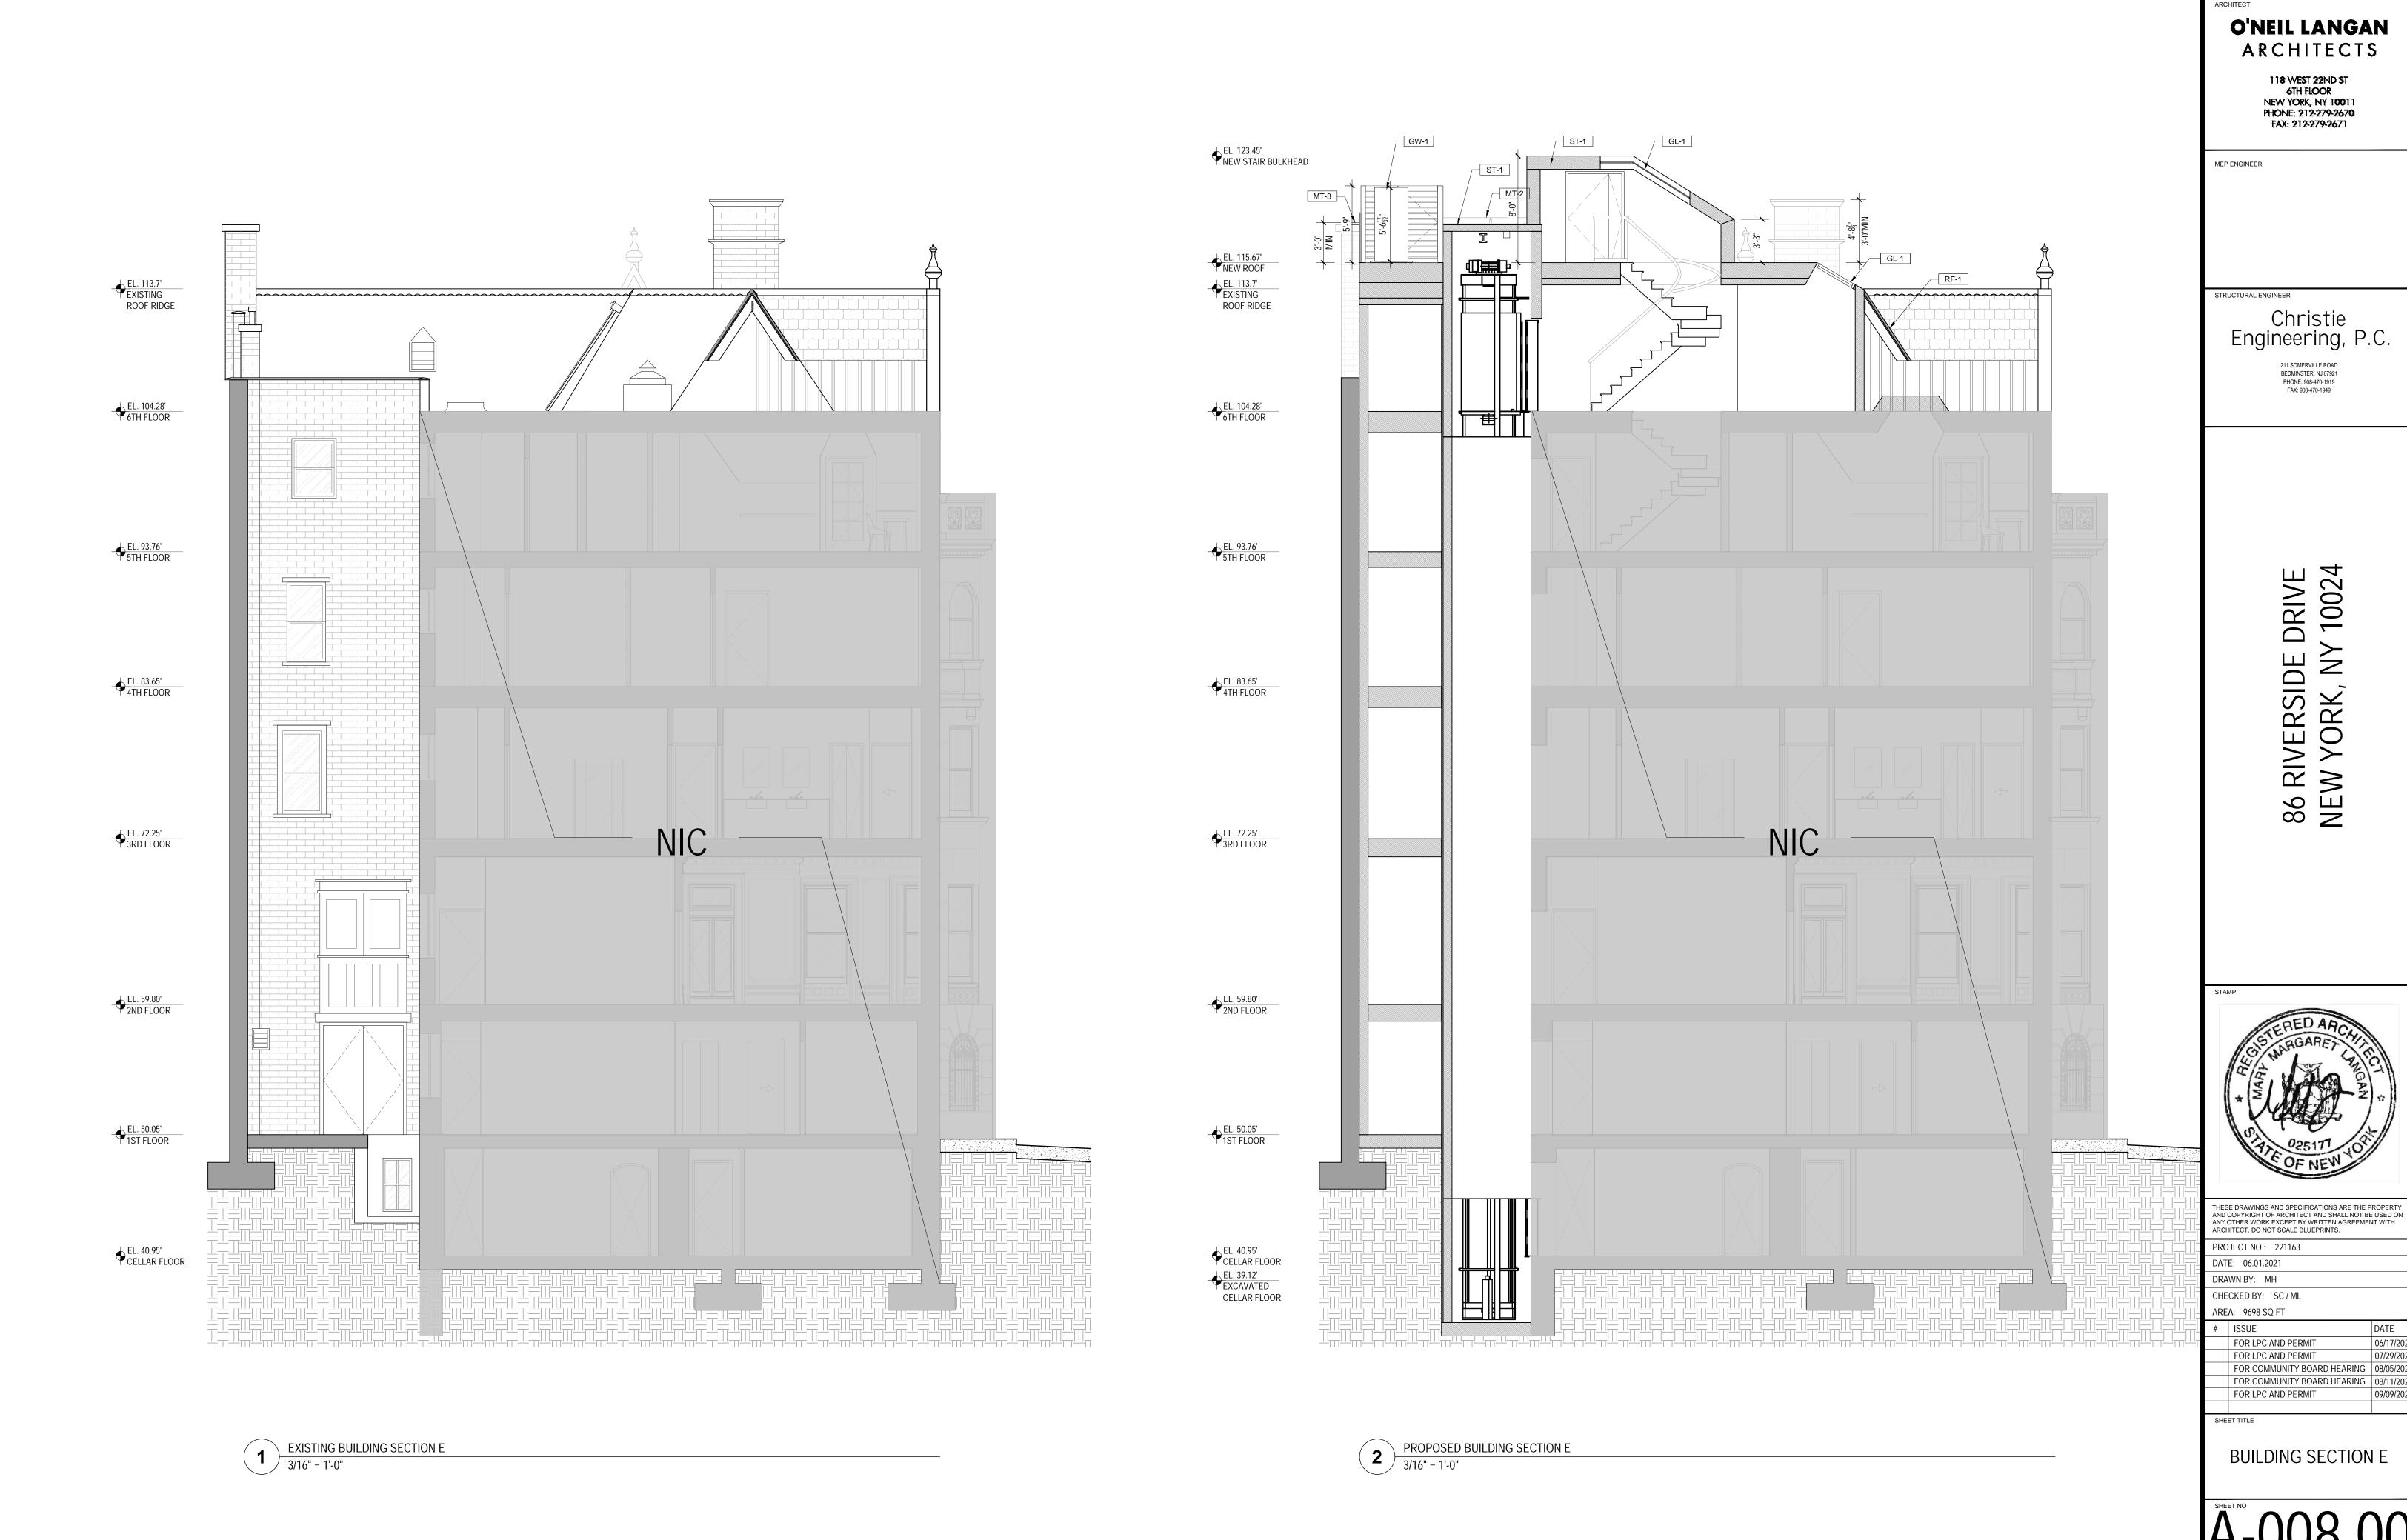

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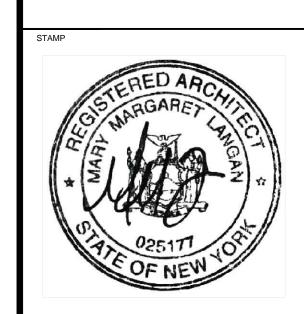
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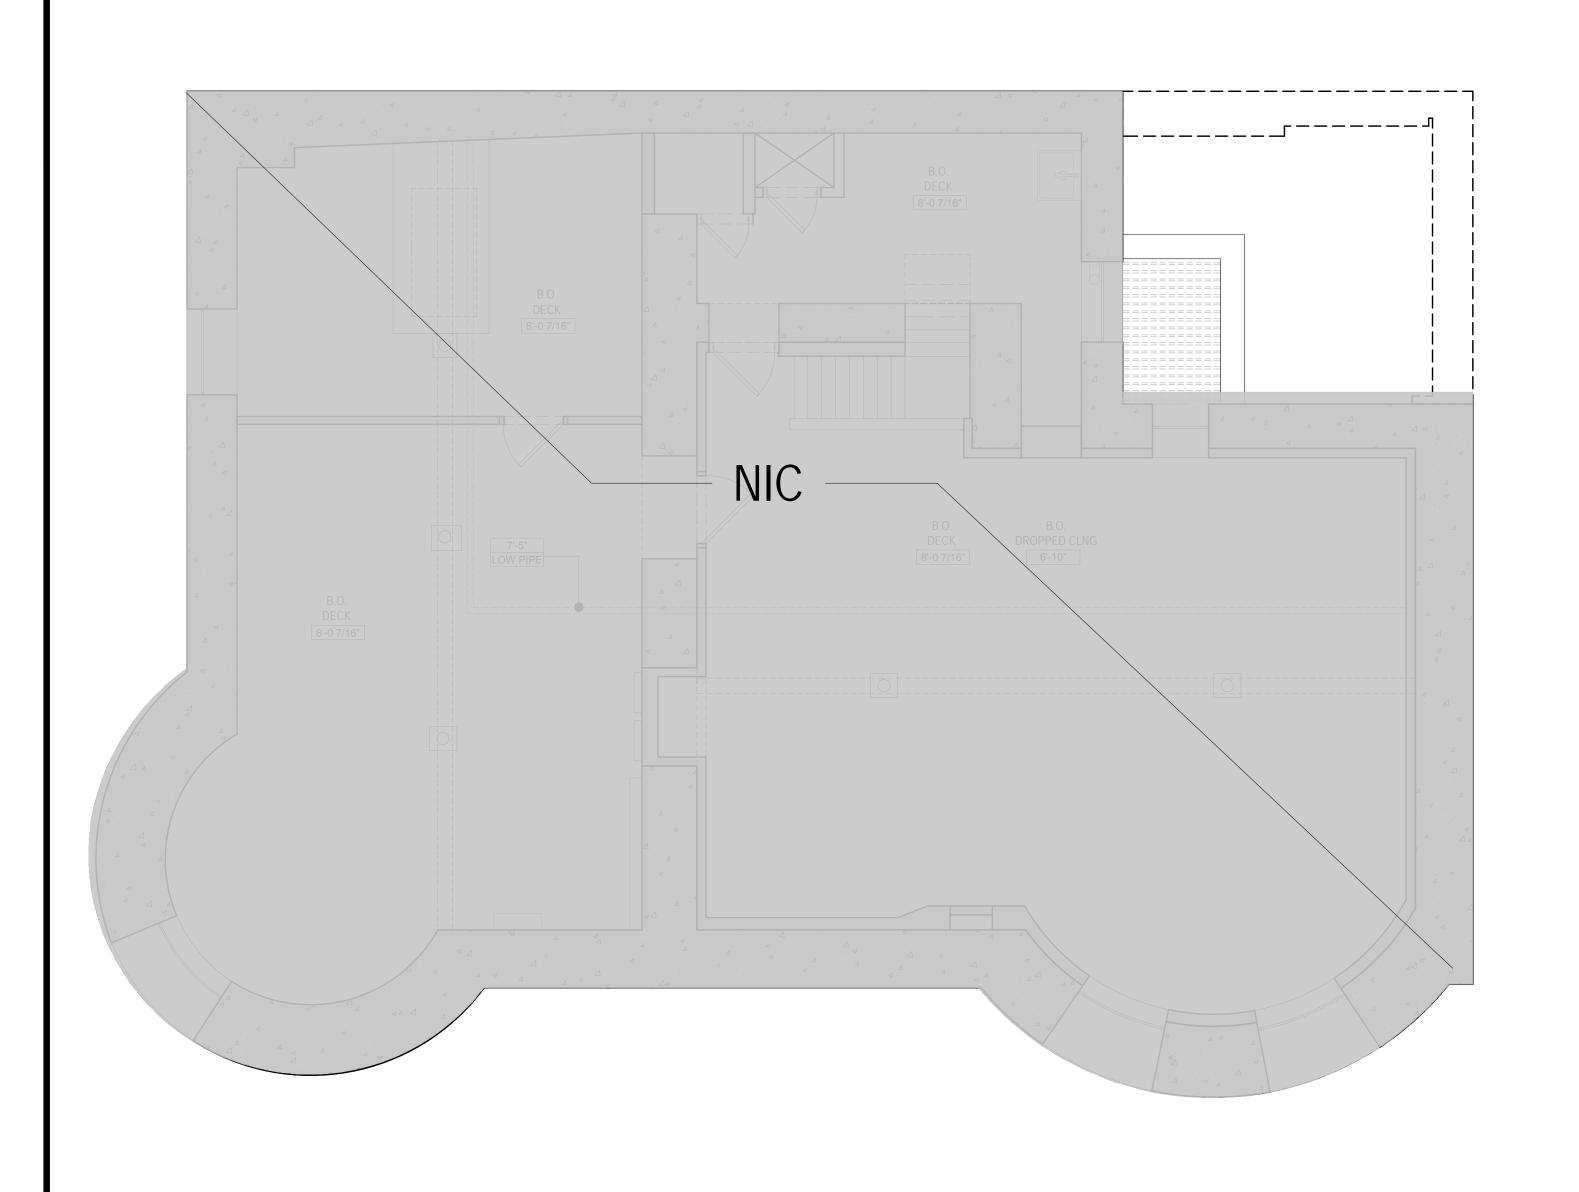
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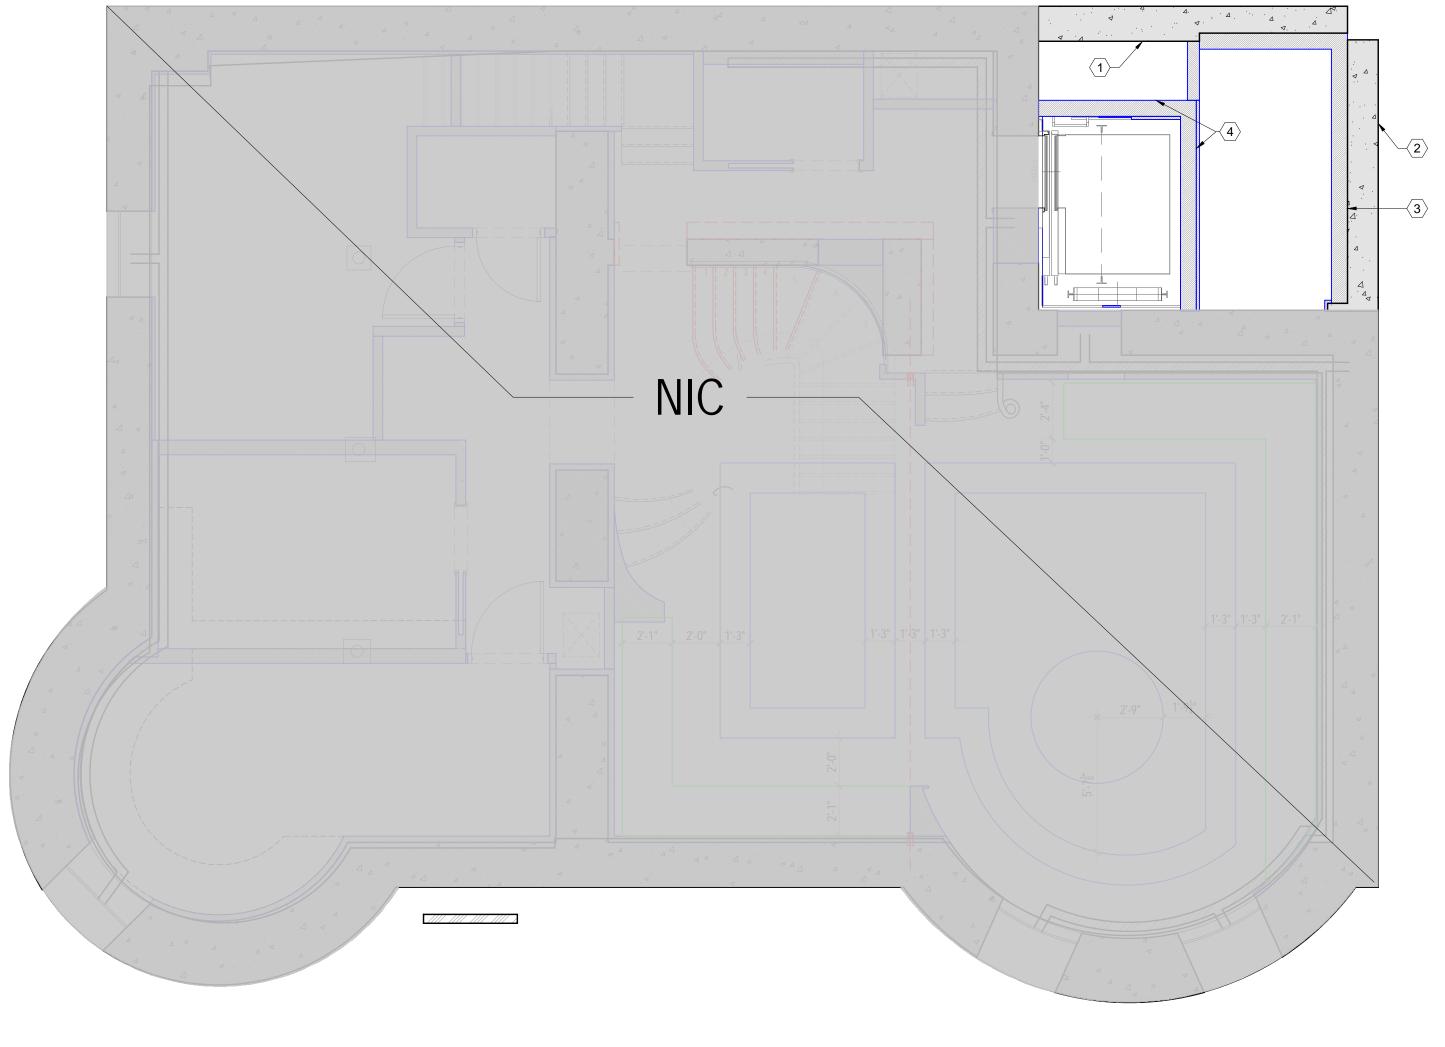
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FOR COMMUNITY BOARD HEARING 08/05/202
FOR COMMUNITY BOARD HEARING 08/11/202
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SHEET TITLE

BUILDING SECTION E STREET VIEW

A-009.00





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MEP ENGINEER

STRUCTURAL ENGINEER

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86 RIVERSIDE DRIVE NEW YORK, NY 10024 YORK, NY

EXISTING PARTITION/ DEMISING WALL

NEW PARTITION - SEE PARTITION TYPES.

LINE OF SOFFIT ABOVE

CONSTRUCTION NOTES

TRADE PRACTICES.

REQUIRED.

THIS CONSTRUCTION.

COMMENCEMENT OF WORK.

APPLIED.

ALL WORK SHALL CONFORM TO THE REQUIREMENTS OF THE NEW

BEFORE COMMENCING WORK, THE CONTRACTOR SHALL FILE ALL

YORK CITY BUILDING CODE 1938 EDITION, FIRE DEPARTMENT REGULATIONS, UTILITY COMPANY REQUIREMENTS AND THE BEST

ALL INTERIOR DIMENSIONS ARE FROM FINISHED FACE U.O.N.

ALL INTERIOR WALLS TO BE AS TAGGED. SEE PARTITION TYPES.

DETAILS NOT SHOWN OR SPECIFIED, BUT NECESSARY FOR PROPER

CONSTRUCT NEW PARTITIONS IN ACCORDANCE W/ LOCAL BUILDING

WALL HUNG COUNTERS, CABINETS AND LIGHT FIXTURES AS MAY BE

CODES AND ALL RULES / REGULATIONS HAVING JURISDICTION.

PROVIDE ALL GROUNDS, BLOCKING AND SUPPORTS TO SUPPORT

D. NO CHANGES IN USE, EGRESS, OR OCCUPANCY SHALL OCCUR WITH

ALL CONDITIONS AND MATERIALS WITHIN THE PROPOSED

12. THE CONTRACTOR SHALL HAVE SOLE RESPONSIBILITY FOR ANY

3. EACH FLOOR IN WHICH CONSTRUCTION IS UNDERTAKEN MUST

REMAIN IN SAFE CONDITIONS WITH REGARD TO FIRE SAFETY FOR

PERSONNEL WORKING ON THE FLOOR. ALL FIRE STAIRS, ALARMS,

4. CONSTRUCTION OPERATIONS TO FOLLOW 340 WEST 57TH STREET

REQUIREMENTS. CONTACT BUILDING MANAGEMENT PRIOR TO

CONDITIONS IN THE FIELD PRIOR TO CONSTRUCTION. CONTACT

6. PROVIDE AND MAINTAIN ADEQUATE PROTECTION FOR ALL FLOORING

. IF APPLICABLE, ALL EXISTING MASONRY CONSTRUCTION SUCH AS

MUST BE FILLED WITH THE SAME MATERIAL BEFORE G.W.B. IS

COLUMNS PIERS AND CORE PARTITIONS, WHERE DISTURBED DUE TO

ADJACENT DEMOLITION ARE TO BE REPLACED AND REPAIRED WITH MATERIAL TO MATCH EXISTING CONSTRUCTION MASONRY OPENINGS

ARCHITECT'S OFFICE IN CASE OF ANY CONFLICTS.

FOR THE DURATION OF CONSTRUCTION.

SPEAKERS, ETC., MUST REMAIN ACCESSIBLE AND OPERABLE AT ALL

REQUIRED WITHOUT ADDITIONAL COST TO OWNER.

. THE CONTRACTOR SHALL BE RESPONSIBLE FOR THE PROTECTION OF

CONSTRUCTION AREA .G.C. SHALL ASSUME RESPONSIBILITY FOR ANY

DAMAGE DONE DURING CONSTRUCTION AND SHALL MAKE REPAIRS

CONSTRUCTION OF ANY PART OF THE WORK SHALL BE INCLUDED AS

OPENING. SEE DOOR SCHEDULE FOR DOOR DETAILS.

BUILDINGS & OBTAIN ALL REQUIRED PERMITS.

IF THEY WERE INDICATED IN THE DRAWINGS.

REQUIREMENTS OF LOCAL AUTHORITIES.

CONSTRUCTION LEGEND:

ROOM NAME ROOM NAME

ROOM NUMBER

KEYNOTE

ELEVATION MARKER

SHEET #

DOOR - SEE DOOR SCHEDULE

EXISTING WINDOW TO REMAIN

ELECTRICAL PANEL

EXISTING INTERCOM

POCKET DOOR - SEE DOOR SCHEDULE

EXISTING PARTITION TREATED WITH WATER

RESISTANT GWB & WATERPROOFING

(LATICRETE #9235 OR EQUAL)





- 18. PARTITIONS SHALL NOT BE FASTENED OR BRACED TO DUCTWORK, CONDUIT OR PIPING. 19. THE CONTRACTOR SHALL LAY OUT HIS OWN WORK, AND SHALL PROVIDE ALL DIMENSIONS REQUIRED FOR OTHER TRADES (PLUMBING.
- 20. PLUMBING AND ELECTRICAL WORK SHALL BE PERFORMED BY REQUIRED CERTIFICATES OF INSURANCE WITH THE DEPARTMENT OF PERSONS LICENSED IN THEIR TRADES, WHO SHALL ARRANGE FOR AND OBTAIN INSPECTIONS AND REQUIRED SIGN-OFFS. ALL DOOR LOCATIONS ARE MEASURED TO THE CENTER OF THE DOOR 21. THE CONTRACTOR SHALL DO ALL CUTTING, PATCHING, REPAIRING AS REQUIRED TO PERFORM ALL OF THE WORK INDICATED ON THE

ELECTRICAL, ETC.)

- COMPLETE THE JOB. 22. ALL MATERIALS, ASSEMBLIES, FORMS AND METHODS OF CONSTRUCTION AND SERVICE EQUIPMENT SHALL COMPLY WITH THE THE CONTRACTOR SHALL COORDINATE ALL WORK PROCEDURES WITH REQUIREMENTS OF SECTION ARTICLE 2, GROUP 3 (2.2.3) (C26-191.0) OF N.Y.C. BUILDING CODE.
 - 23. PROVIDE FIRE STOPPING AT PENETRATIONS IN RATED ASSEMBLIES. 24. THE CONTRACTOR SHALL CERTIFY THAT ALL WALLS, ETC. SCHEDULED TO BE REMOVED ARE NOT STRUCTURAL BEARING WALLS.

DRAWINGS, AND ALL OTHER WORK THAT MAY BE REQUIRED TO


- 25. EXISTING EXHAUST VENTILATION AT BATH SHALL REMAIN AND BE MAINTAINED. DUST PROTECTION SHALL BE USED DURING CONSTRUCTION. WHEN CONSTRUCTION IS COMPLETE ALL EXHAUST SYSTEMS SHALL BE RETURNED TO ORIGINAL CONDITIONS IF APPLICABLE
- 26. FLOOR LOADING OF ALL EQUIPMENT, FURNITURE, TENANT CONSTRUCTION ETC., SHALL NOT EXCEED THE STRUCTURAL CAPACITY OF THE BUILDING.
- 27. NO CHANGES ARE TO BE MADE TO THIS PLAN OR THE PROPOSED SCOPE OF WORK WITHOUT THE CONSOLATION AND APPROVAL IN WRITING OF THE ARCHITECT.
- DAMAGE OR INJURIES CAUSED BY OR DURING THE EXECUTION OF THE 28. THE REVIEW OF SHOP DRAWINGS SHALL NOT BE CONSTRUED AS A COMPLETE CHECK BUT WILL INDICATE ONLY THAT THE GENERAL METHOD OF CONSTRUCTION AND DETAILING IS SATISFACTORY. REVIEW OF SUCH DRAWINGS WILL NOT RELIEVE THE CONTRACTOR OF THE RESPONSIBILITY FOR ERRORS OF FABRICATION WHICH MAY EXIST AS THE CONTRACTOR SHALL BE RESPONSIBLE FOR THE DIMENSIONS AND DESIGN OF ADEQUATE CONNECTIONS, DETAILS AND FOR THE CORRECT FITTING OF THE STRUCTURAL MEMBERS.
- 29. ALL LABOR SHALL BE PERFORMED IN THE BEST AND MOST 5. G.C. TO VERIFY ALL DIMENSIONS, CEILING HEIGHTS, AND EXISTING WORKMANLIKE MANNER BY MECHANICS SKILLED IN THEIR RESPECTIVE TRADES.
 - 30. THE GENERAL CONTRACTOR SHALL COORDINATE THE SCHEDULING OF ALL TRADES. 31. THE GENERAL CONTRACTOR IS CAUTIONED TO MAKE CONTINUOUS
 - OBSERVATIONS OF THE EXISTING STRUCTURE DURING THE PERFORMANCE OF WORK. SHOULD ANY SITUATIONS THAT REQUIRE FURTHER INVESTIGATION OR STUDY ARISE, GC TO NOTIFY THE ARCHITECT IMMEDIATELY IN WRITING.

CELLAR FLOOR PROPOSED CONSTRUCTION PLAN



- (2) EXISTING NEIGHBOR'S MASONRY WALL

- (4) NEW ELEVATOR HOISTWAY, 8" THK CMU, TYP.
- (6) NEW 12" METAL STUD WALL

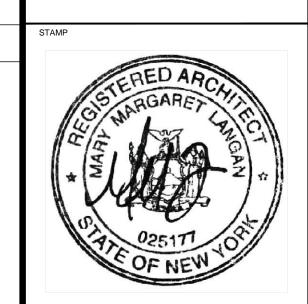

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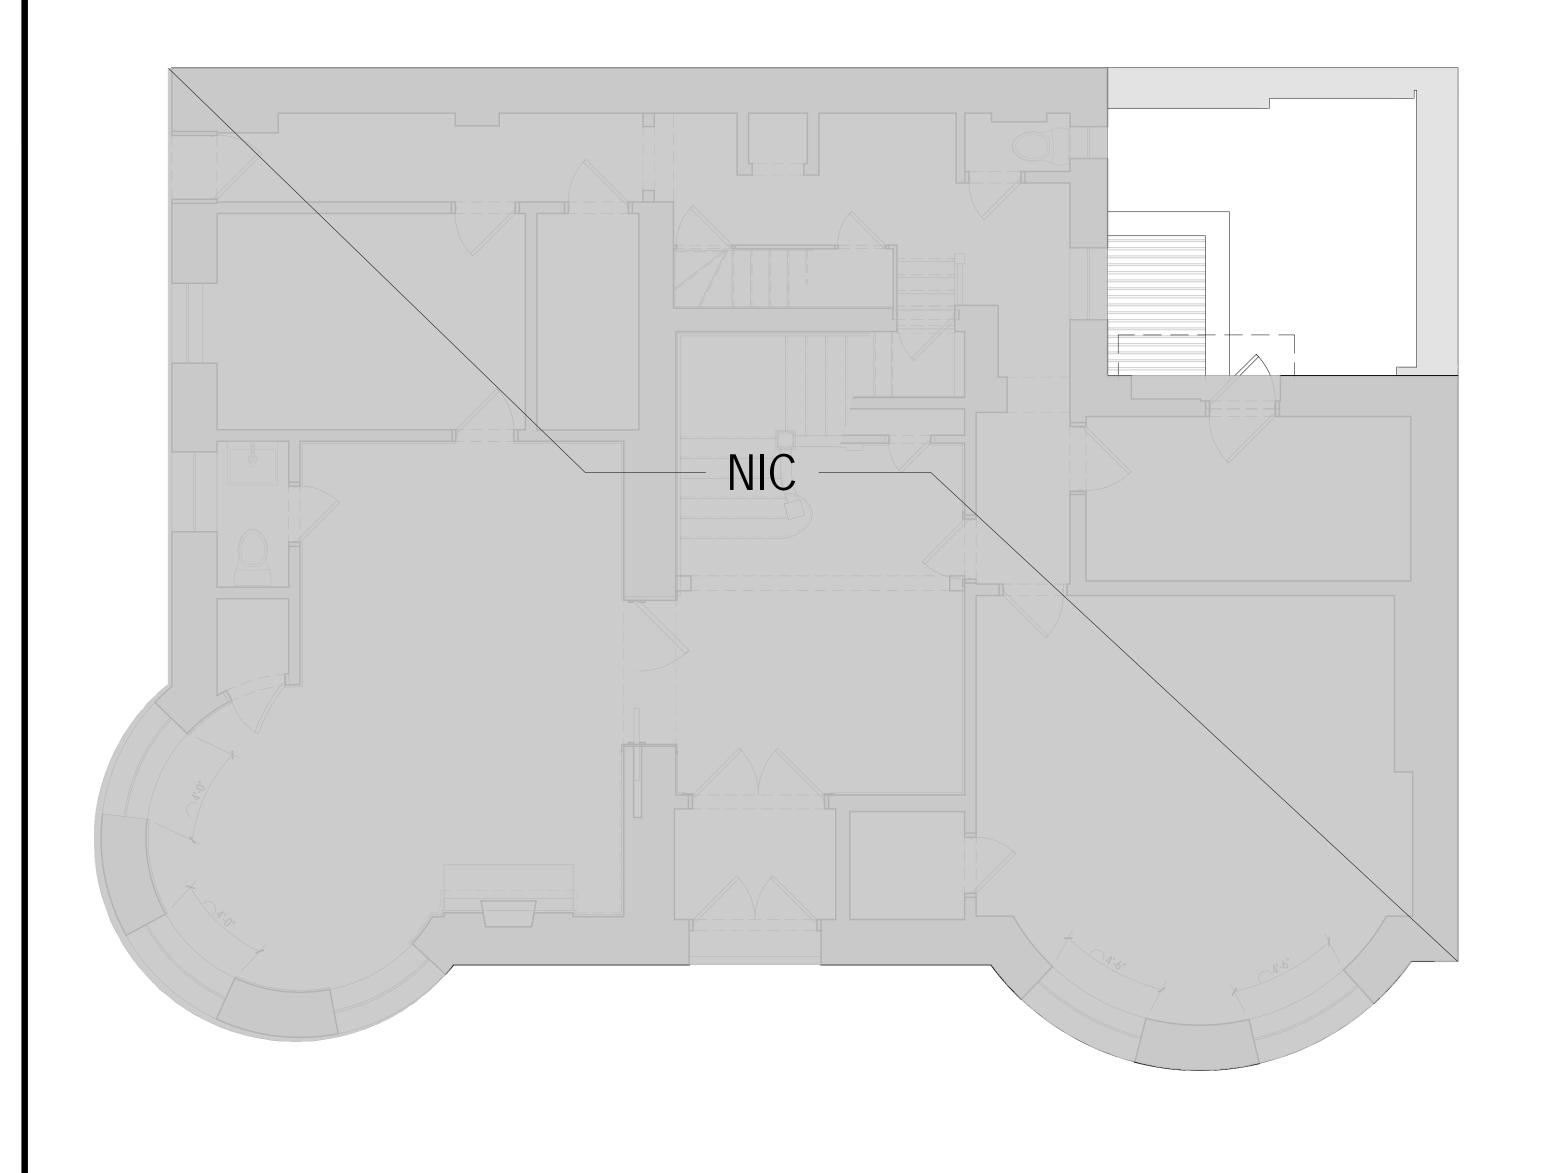
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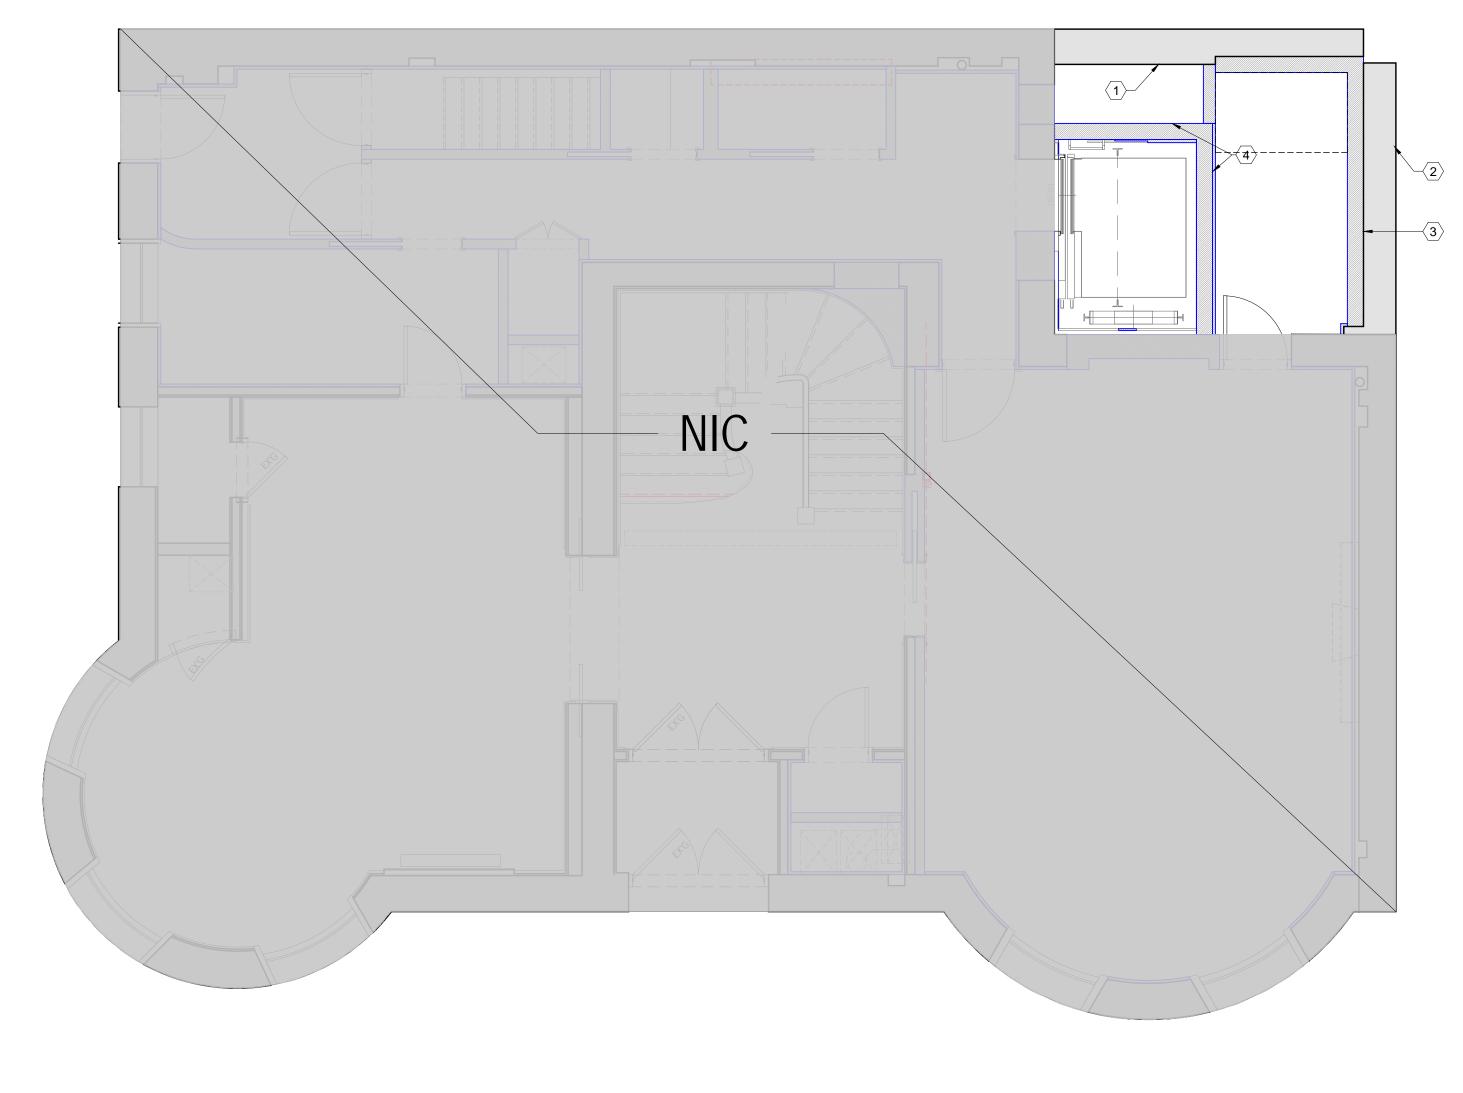
SHEET TITLE

CELLAR FLOOR CONSTRUCTION PLAN

CONSTRUCTION KEYNOTES

- (1) EXISTING MASONRY PARTY WALL
- $\langle \mathsf{3}
 angle$ NEW 6" METAL STUD WALL
- (5) NEW 2X6 WOOD STUD WALL





\ 1ST FLOOR PROPOSED CONSTRUCTION PLAN

O'NEIL LANGAN ARCHITECTS

118 WEST 22ND ST 6TH FLOOR NEW YORK, NY 10011 PHONE: 212-279-2670 FAX: 212-279-2671

MEP ENGINEER

Christie Engineering, P.C.

211 SOMERVILLE ROAD BEDMINSTER, NJ 07921 PHONE: 908-470-1919 FAX: 908-470-1949

10024 86 RIVERSIDE DRIVE NEW YORK, NY 10024

EXISTING PARTITION/ DEMISING WALL

NEW PARTITION - SEE PARTITION TYPES.

LINE OF SOFFIT ABOVE

CONSTRUCTION LEGEND:

ROOM NAME ROOM NAME

ROOM NUMBER

KEYNOTE

ELEVATION MARKER

SHEET #

DOOR - SEE DOOR SCHEDULE

EXISTING WINDOW TO REMAIN

ELECTRICAL PANEL

EXISTING INTERCOM

POCKET DOOR - SEE DOOR SCHEDULE

EXISTING PARTITION TREATED WITH WATER

RESISTANT GWB & WATERPROOFING

(LATICRETE #9235 OR EQUAL)



YORK CITY BUILDING CODE 1938 EDITION, FIRE DEPARTMENT REGULATIONS, UTILITY COMPANY REQUIREMENTS AND THE BEST

ALL INTERIOR DIMENSIONS ARE FROM FINISHED FACE U.O.N.

ALL INTERIOR WALLS TO BE AS TAGGED. SEE PARTITION TYPES.

DETAILS NOT SHOWN OR SPECIFIED, BUT NECESSARY FOR PROPER

CONSTRUCT NEW PARTITIONS IN ACCORDANCE W/ LOCAL BUILDING

WALL HUNG COUNTERS, CABINETS AND LIGHT FIXTURES AS MAY BE

CODES AND ALL RULES / REGULATIONS HAVING JURISDICTION.

PROVIDE ALL GROUNDS, BLOCKING AND SUPPORTS TO SUPPORT

D. NO CHANGES IN USE, EGRESS, OR OCCUPANCY SHALL OCCUR WITH

ALL CONDITIONS AND MATERIALS WITHIN THE PROPOSED

12. THE CONTRACTOR SHALL HAVE SOLE RESPONSIBILITY FOR ANY

3. EACH FLOOR IN WHICH CONSTRUCTION IS UNDERTAKEN MUST

REMAIN IN SAFE CONDITIONS WITH REGARD TO FIRE SAFETY FOR

PERSONNEL WORKING ON THE FLOOR. ALL FIRE STAIRS, ALARMS,

4. CONSTRUCTION OPERATIONS TO FOLLOW 340 WEST 57TH STREET

REQUIREMENTS. CONTACT BUILDING MANAGEMENT PRIOR TO

CONDITIONS IN THE FIELD PRIOR TO CONSTRUCTION. CONTACT

6. PROVIDE AND MAINTAIN ADEQUATE PROTECTION FOR ALL FLOORING

. IF APPLICABLE, ALL EXISTING MASONRY CONSTRUCTION SUCH AS

MUST BE FILLED WITH THE SAME MATERIAL BEFORE G.W.B. IS

COLUMNS PIERS AND CORE PARTITIONS, WHERE DISTURBED DUE TO

ADJACENT DEMOLITION ARE TO BE REPLACED AND REPAIRED WITH

MATERIAL TO MATCH EXISTING CONSTRUCTION MASONRY OPENINGS

ARCHITECT'S OFFICE IN CASE OF ANY CONFLICTS.

FOR THE DURATION OF CONSTRUCTION.

SPEAKERS, ETC., MUST REMAIN ACCESSIBLE AND OPERABLE AT ALL

REQUIRED WITHOUT ADDITIONAL COST TO OWNER.

. THE CONTRACTOR SHALL BE RESPONSIBLE FOR THE PROTECTION OF

CONSTRUCTION AREA .G.C. SHALL ASSUME RESPONSIBILITY FOR ANY

DAMAGE DONE DURING CONSTRUCTION AND SHALL MAKE REPAIRS

CONSTRUCTION OF ANY PART OF THE WORK SHALL BE INCLUDED AS

OPENING. SEE DOOR SCHEDULE FOR DOOR DETAILS.

BUILDINGS & OBTAIN ALL REQUIRED PERMITS.

IF THEY WERE INDICATED IN THE DRAWINGS.

REQUIREMENTS OF LOCAL AUTHORITIES.

BEFORE COMMENCING WORK, THE CONTRACTOR SHALL FILE ALL

TRADE PRACTICES.

REQUIRED.

THIS CONSTRUCTION.

COMMENCEMENT OF WORK.


APPLIED.



- 20. PLUMBING AND ELECTRICAL WORK SHALL BE PERFORMED BY PERSONS LICENSED IN THEIR TRADES, WHO SHALL ARRANGE FOR AND OBTAIN INSPECTIONS AND REQUIRED SIGN-OFFS.
- COMPLETE THE JOB. 22. ALL MATERIALS, ASSEMBLIES, FORMS AND METHODS OF THE CONTRACTOR SHALL COORDINATE ALL WORK PROCEDURES WITH
 - OF N.Y.C. BUILDING CODE. 23. PROVIDE FIRE STOPPING AT PENETRATIONS IN RATED ASSEMBLIES. 24. THE CONTRACTOR SHALL CERTIFY THAT ALL WALLS, ETC. SCHEDULED
 - 25. EXISTING EXHAUST VENTILATION AT BATH SHALL REMAIN AND BE MAINTAINED. DUST PROTECTION SHALL BE USED DURING SYSTEMS SHALL BE RETURNED TO ORIGINAL CONDITIONS IF APPLICABLE
 - 26. FLOOR LOADING OF ALL EQUIPMENT, FURNITURE, TENANT CAPACITY OF THE BUILDING.
- DAMAGE OR INJURIES CAUSED BY OR DURING THE EXECUTION OF THE COMPLETE CHECK BUT WILL INDICATE ONLY THAT THE GENERAL METHOD OF CONSTRUCTION AND DETAILING IS SATISFACTORY. THE RESPONSIBILITY FOR ERRORS OF FABRICATION WHICH MAY EXIST AS THE CONTRACTOR SHALL BE RESPONSIBLE FOR THE FOR THE CORRECT FITTING OF THE STRUCTURAL MEMBERS.
- 5. G.C. TO VERIFY ALL DIMENSIONS, CEILING HEIGHTS, AND EXISTING RESPECTIVE TRADES.
 - 30. THE GENERAL CONTRACTOR SHALL COORDINATE THE SCHEDULING OF ALL TRADES.
 - 31. THE GENERAL CONTRACTOR IS CAUTIONED TO MAKE CONTINUOUS OBSERVATIONS OF THE EXISTING STRUCTURE DURING THE FURTHER INVESTIGATION OR STUDY ARISE, GC TO NOTIFY THE ARCHITECT IMMEDIATELY IN WRITING.

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PROJECT NO.: 221163 DATE: 06.01.2021 DRAWN BY: MH CHECKED BY: SC/ML

AREA: 9698 SQ FT # ISSUE FOR LPC AND PERMIT

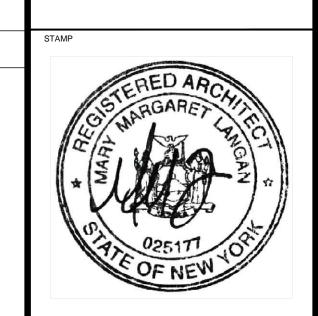06/17/20 FOR LPC AND PERMIT FOR COMMUNITY BOARD HEARING 08/05/20 FOR COMMUNITY BOARD HEARING | 08/11/20 FOR LPC AND PERMIT


DATE


SHEET TITLE

1ST FLOOR CONSTRUCTION PLAN



- CONDUIT OR PIPING. 19. THE CONTRACTOR SHALL LAY OUT HIS OWN WORK, AND SHALL PROVIDE ALL DIMENSIONS REQUIRED FOR OTHER TRADES (PLUMBING. ELECTRICAL, ETC.)
- REQUIRED CERTIFICATES OF INSURANCE WITH THE DEPARTMENT OF ALL DOOR LOCATIONS ARE MEASURED TO THE CENTER OF THE DOOR 21. THE CONTRACTOR SHALL DO ALL CUTTING, PATCHING, REPAIRING AS REQUIRED TO PERFORM ALL OF THE WORK INDICATED ON THE DRAWINGS, AND ALL OTHER WORK THAT MAY BE REQUIRED TO
 - CONSTRUCTION AND SERVICE EQUIPMENT SHALL COMPLY WITH THE REQUIREMENTS OF SECTION ARTICLE 2, GROUP 3 (2.2.3) (C26-191.0)
 - TO BE REMOVED ARE NOT STRUCTURAL BEARING WALLS.
 - CONSTRUCTION. WHEN CONSTRUCTION IS COMPLETE ALL EXHAUST
 - CONSTRUCTION ETC., SHALL NOT EXCEED THE STRUCTURAL
 - 27. NO CHANGES ARE TO BE MADE TO THIS PLAN OR THE PROPOSED SCOPE OF WORK WITHOUT THE CONSOLATION AND APPROVAL IN WRITING OF THE ARCHITECT.
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 - 29. ALL LABOR SHALL BE PERFORMED IN THE BEST AND MOST WORKMANLIKE MANNER BY MECHANICS SKILLED IN THEIR
 - PERFORMANCE OF WORK. SHOULD ANY SITUATIONS THAT REQUIRE

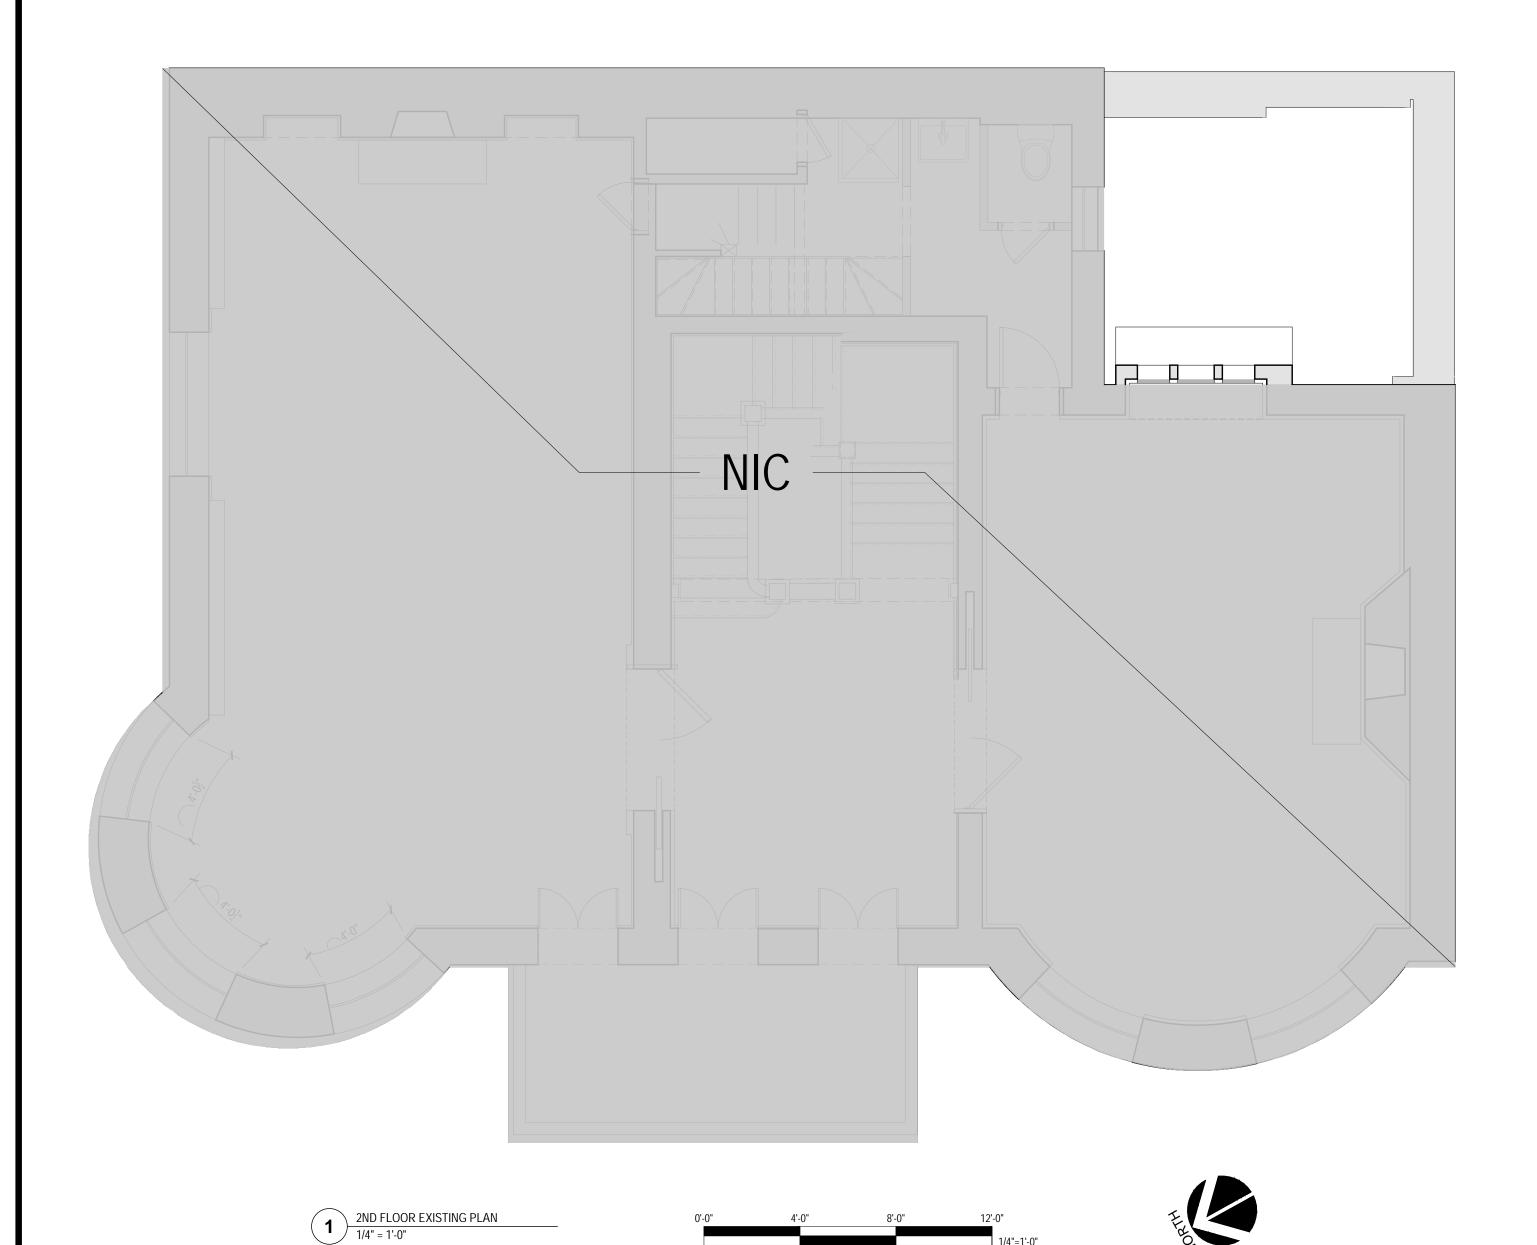

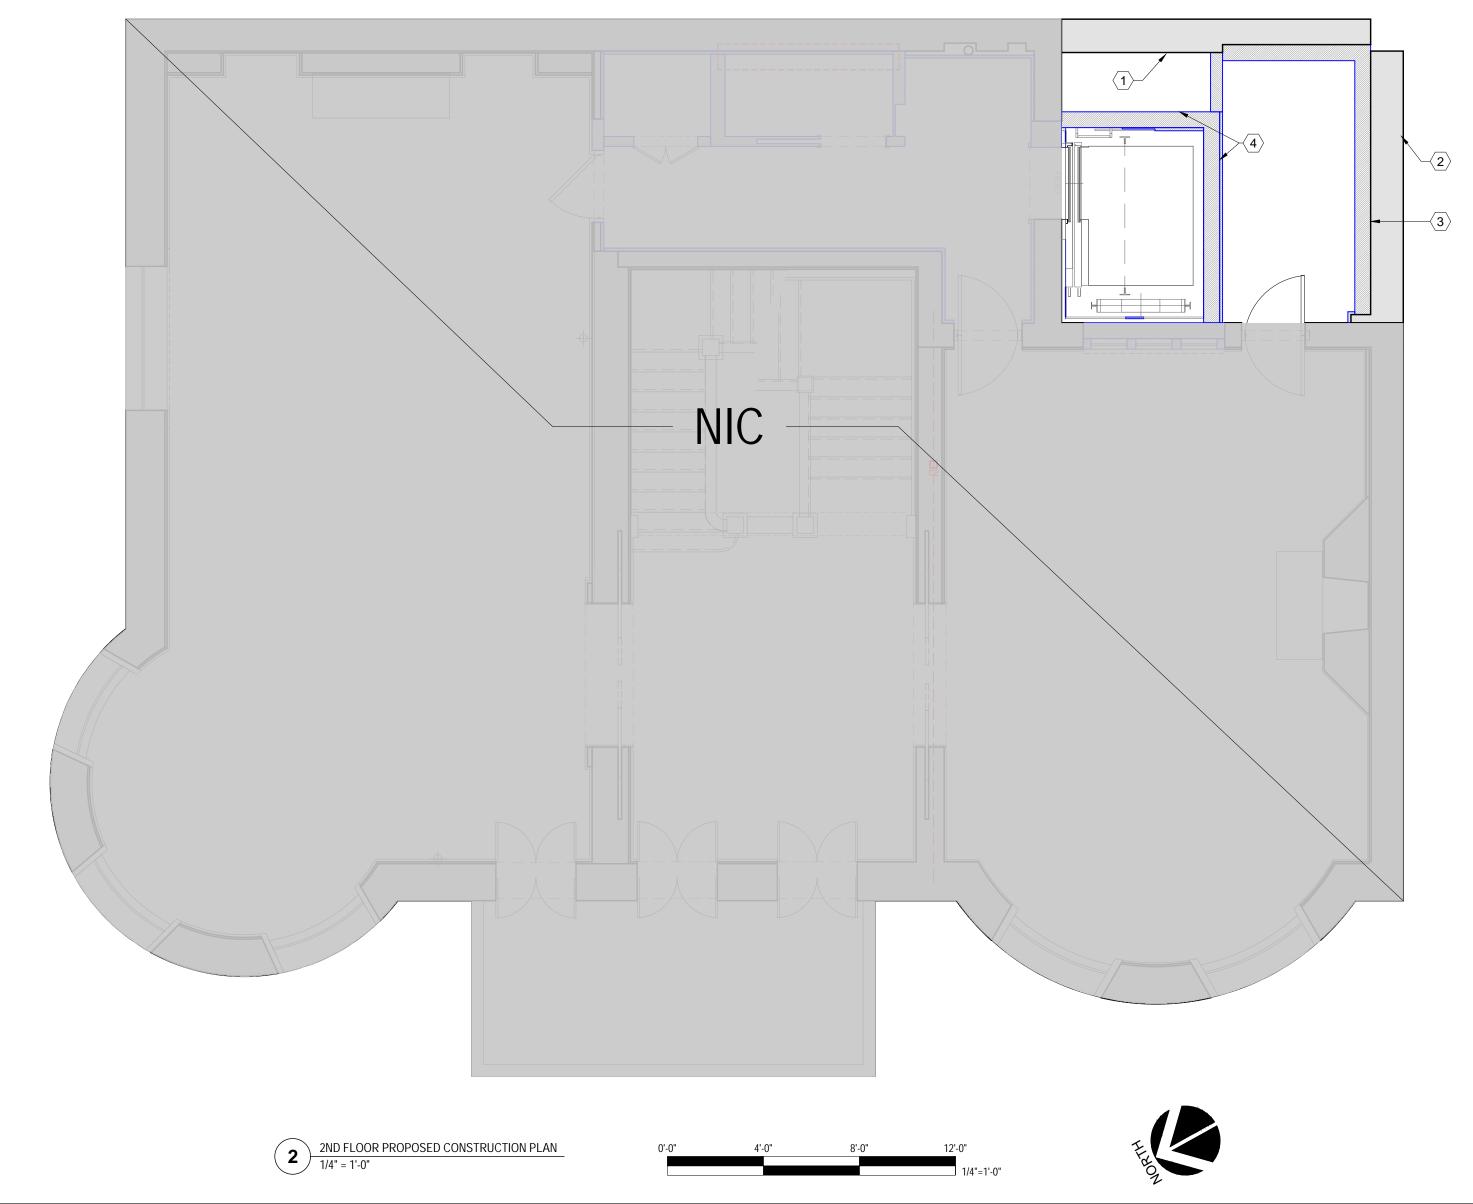

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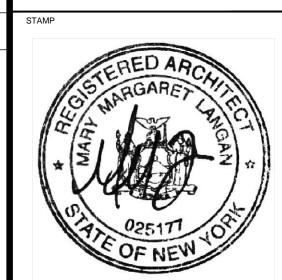
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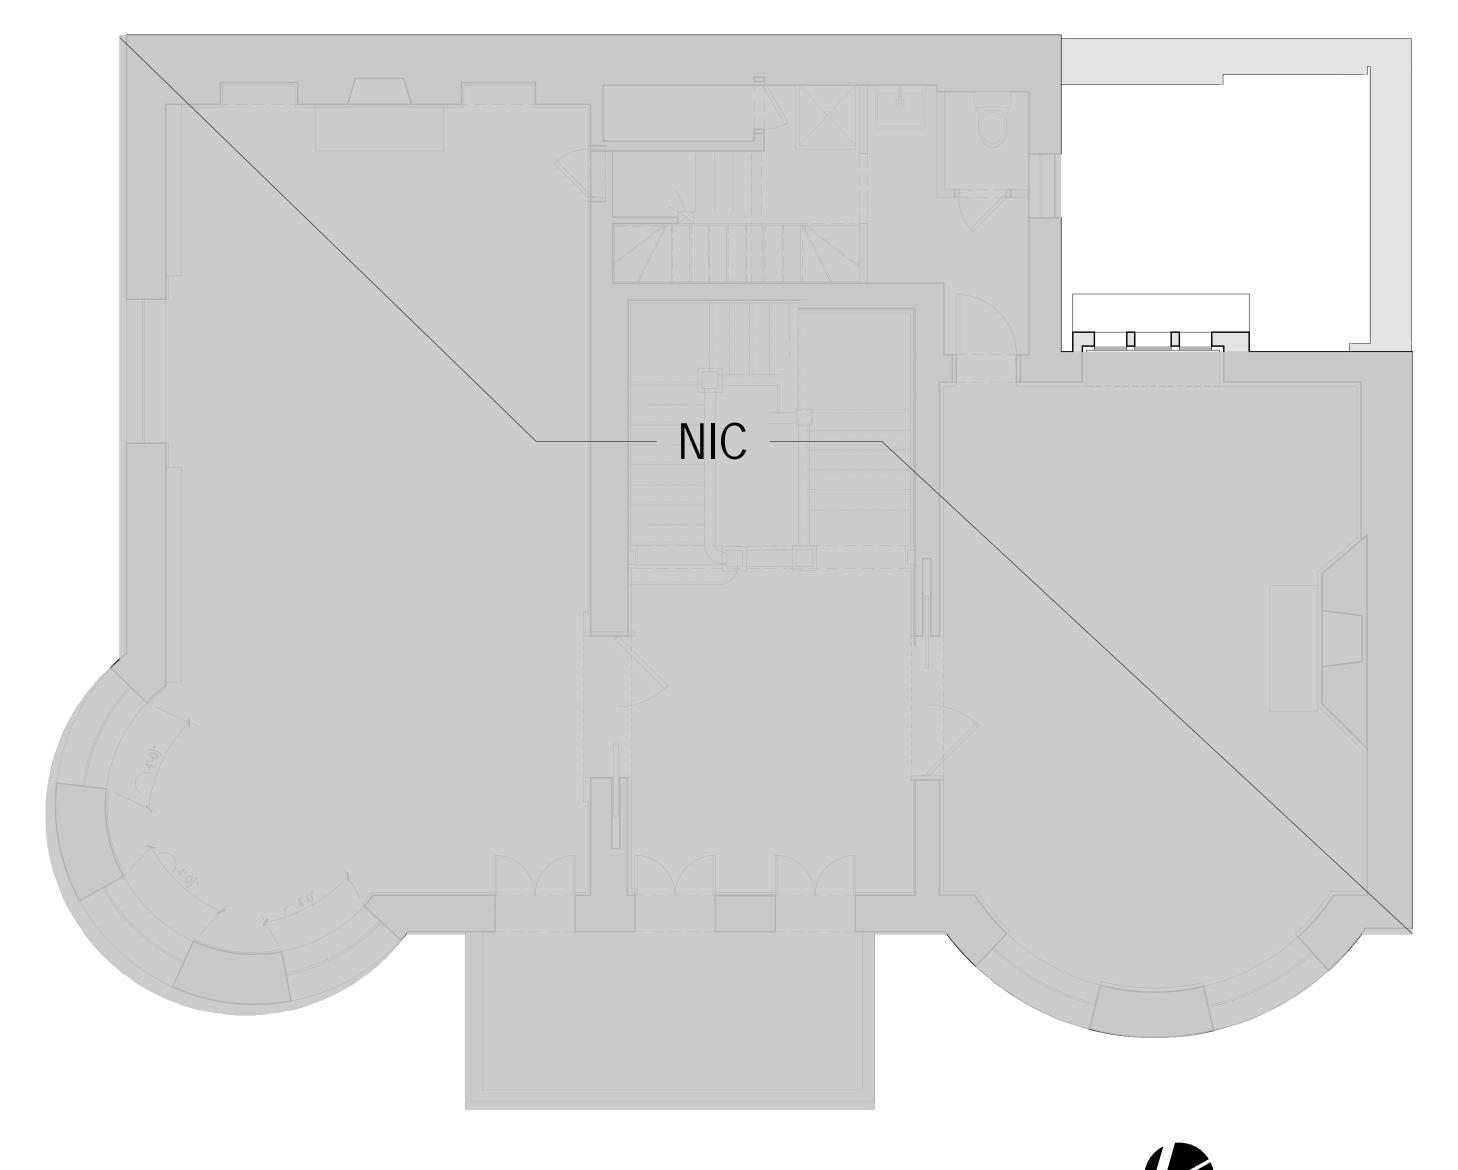
AREA: 9698 SQ FT # ISSUE FOR LPC AND PERMIT FOR LPC AND PERMIT


06/17/20 FOR COMMUNITY BOARD HEARING 08/05/20 FOR COMMUNITY BOARD HEARING | 08/11/20 FOR LPC AND PERMIT

DATE

SHEET TITLE

2ND FLOOR CONSTRUCTION PLAN



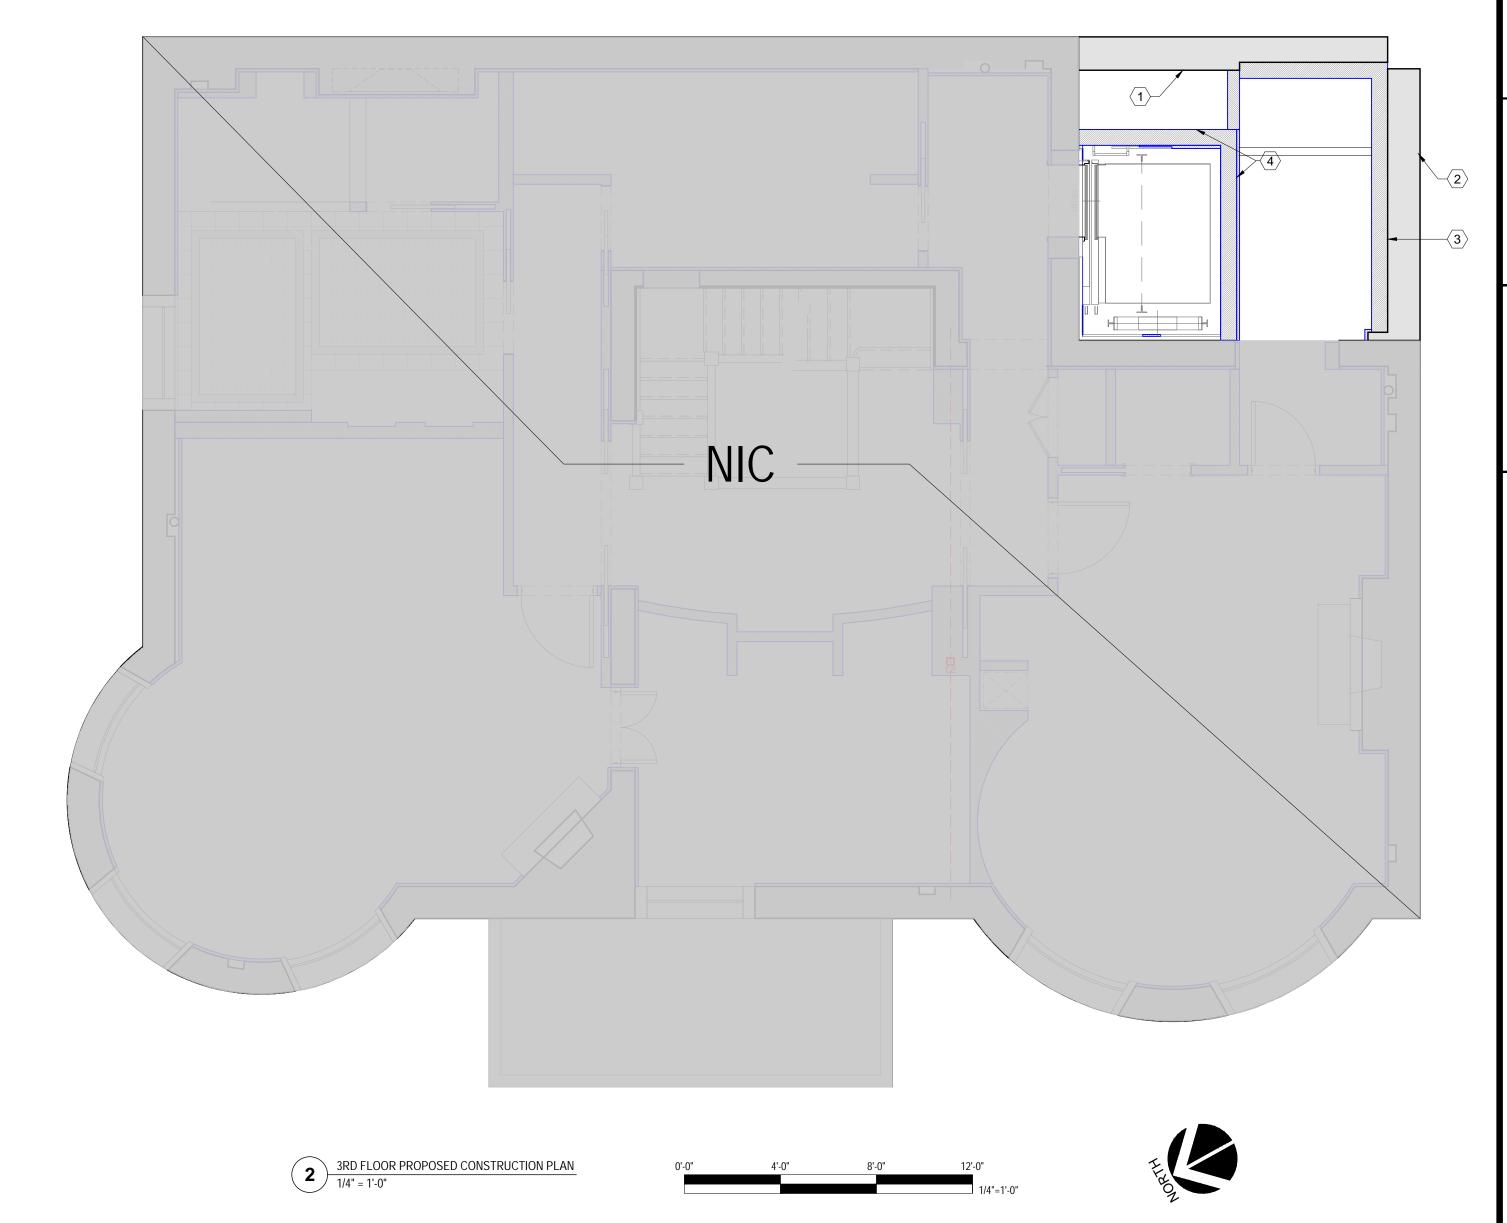

EXISTING PARTITION/ DEMISING WALL

NEW PARTITION - SEE PARTITION TYPES.

LINE OF SOFFIT ABOVE

CONSTRUCTION LEGEND:

ROOM NAME ROOM NAME

ROOM NUMBER

KEYNOTE

ELEVATION MARKER

- SHEET#

DOOR - SEE DOOR SCHEDULE

EXISTING WINDOW TO REMAIN

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EXISTING PARTITION TREATED WITH WATER

RESISTANT GWB & WATERPROOFING

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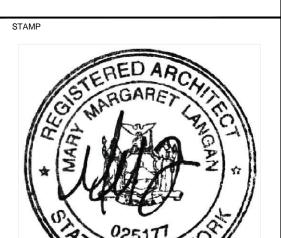
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O'NEIL LANGAN

ARCHITECTS

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10024

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STRUCTURAL ENGINEER

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SHEET TITLE

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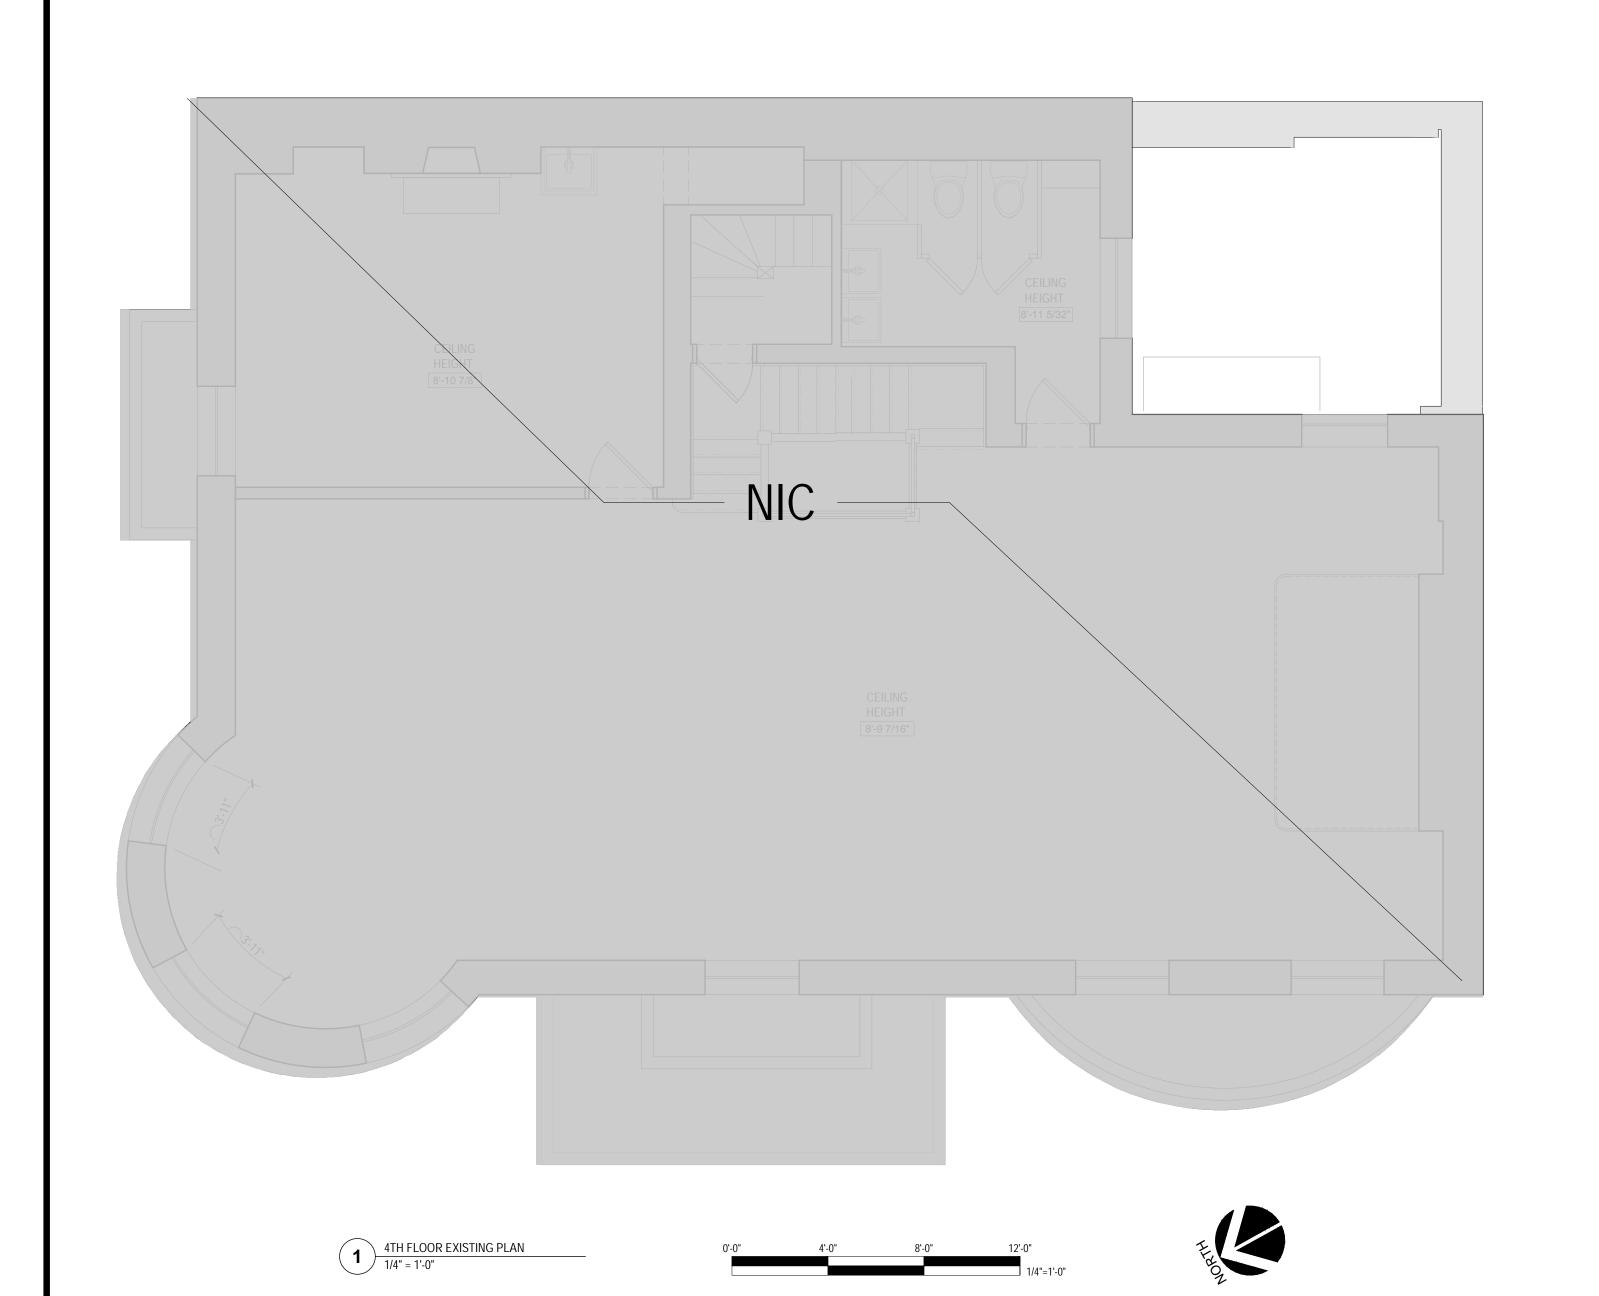
06/17/20


3RD FLOOR CONSTRUCTION PLAN

CONSTRUCTION KEYNOTES

- 1 EXISTING MASONRY PARTY WALL

- (6) NEW 12" METAL STUD WALL



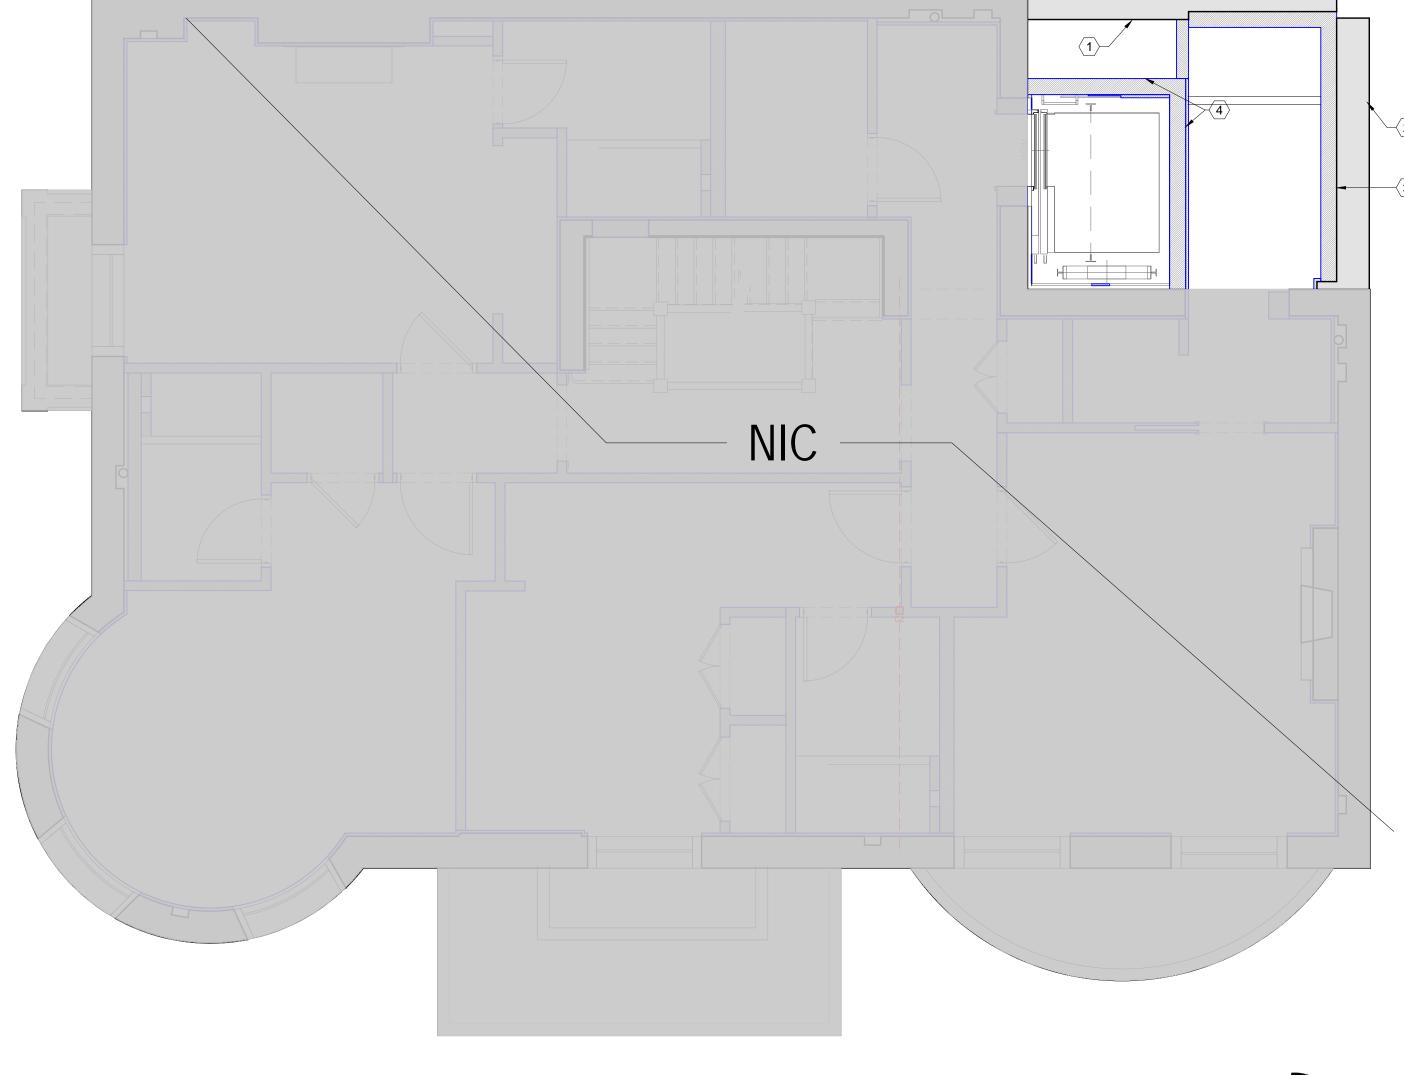

4TH FLOOR PROPOSED CONSTRUCTION PLAN

CONSTRUCTION LEGEND: EXISTING PARTITION/ DEMISING WALL LINE OF SOFFIT ABOVE NEW PARTITION - SEE PARTITION TYPES. ROOM NAME ROOM NAME ## ROOM NUMBER KEYNOTE **ELEVATION MARKER** - SHEET# DOOR - SEE DOOR SCHEDULE POCKET DOOR - SEE DOOR SCHEDULE EXISTING WINDOW TO REMAIN ELECTRICAL PANEL EXISTING INTERCOM EXISTING PARTITION TREATED WITH WATER RESISTANT GWB & WATERPROOFING

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5. G.C. TO VERIFY ALL DIMENSIONS, CEILING HEIGHTS, AND EXISTING CONDITIONS IN THE FIELD PRIOR TO CONSTRUCTION. CONTACT ARCHITECT'S OFFICE IN CASE OF ANY CONFLICTS. 6. PROVIDE AND MAINTAIN ADEQUATE PROTECTION FOR ALL FLOORING

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- 18. PARTITIONS SHALL NOT BE FASTENED OR BRACED TO DUCTWORK, CONDUIT OR PIPING.
- 19. THE CONTRACTOR SHALL LAY OUT HIS OWN WORK, AND SHALL PROVIDE ALL DIMENSIONS REQUIRED FOR OTHER TRADES (PLUMBING. ELECTRICAL, ETC.)
- 20. PLUMBING AND ELECTRICAL WORK SHALL BE PERFORMED BY PERSONS LICENSED IN THEIR TRADES, WHO SHALL ARRANGE FOR AND OBTAIN INSPECTIONS AND REQUIRED SIGN-OFFS. ALL DOOR LOCATIONS ARE MEASURED TO THE CENTER OF THE DOOR 21. THE CONTRACTOR SHALL DO ALL CUTTING, PATCHING, REPAIRING AS REQUIRED TO PERFORM ALL OF THE WORK INDICATED ON THE


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- COMPLETE THE JOB. 22. ALL MATERIALS, ASSEMBLIES, FORMS AND METHODS OF CONSTRUCTION AND SERVICE EQUIPMENT SHALL COMPLY WITH THE REQUIREMENTS OF SECTION ARTICLE 2, GROUP 3 (2.2.3) (C26-191.0) OF N.Y.C. BUILDING CODE.
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- 25. EXISTING EXHAUST VENTILATION AT BATH SHALL REMAIN AND BE MAINTAINED. DUST PROTECTION SHALL BE USED DURING CONSTRUCTION. WHEN CONSTRUCTION IS COMPLETE ALL EXHAUST SYSTEMS SHALL BE RETURNED TO ORIGINAL CONDITIONS IF APPLICABLE
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- 27. NO CHANGES ARE TO BE MADE TO THIS PLAN OR THE PROPOSED SCOPE OF WORK WITHOUT THE CONSOLATION AND APPROVAL IN WRITING OF THE ARCHITECT.
- 28. THE REVIEW OF SHOP DRAWINGS SHALL NOT BE CONSTRUED AS A COMPLETE CHECK BUT WILL INDICATE ONLY THAT THE GENERAL METHOD OF CONSTRUCTION AND DETAILING IS SATISFACTORY. REVIEW OF SUCH DRAWINGS WILL NOT RELIEVE THE CONTRACTOR OF THE RESPONSIBILITY FOR ERRORS OF FABRICATION WHICH MAY EXIST AS THE CONTRACTOR SHALL BE RESPONSIBLE FOR THE DIMENSIONS AND DESIGN OF ADEQUATE CONNECTIONS, DETAILS AND FOR THE CORRECT FITTING OF THE STRUCTURAL MEMBERS.
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30. THE GENERAL CONTRACTOR SHALL COORDINATE THE SCHEDULING

CONSTRUCTION KEYNOTES

- 1 EXISTING MASONRY PARTY WALL
- (2) EXISTING NEIGHBOR'S MASONRY WALL
- (3) NEW 6" METAL STUD WALL
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- (5) NEW 2X6 WOOD STUD WALL
- (6) NEW 12" METAL STUD WALL



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STRUCTURAL ENGINEER
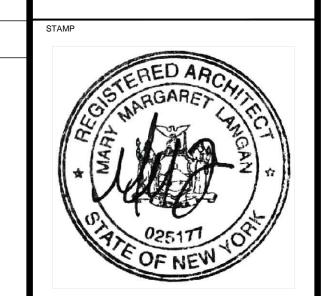
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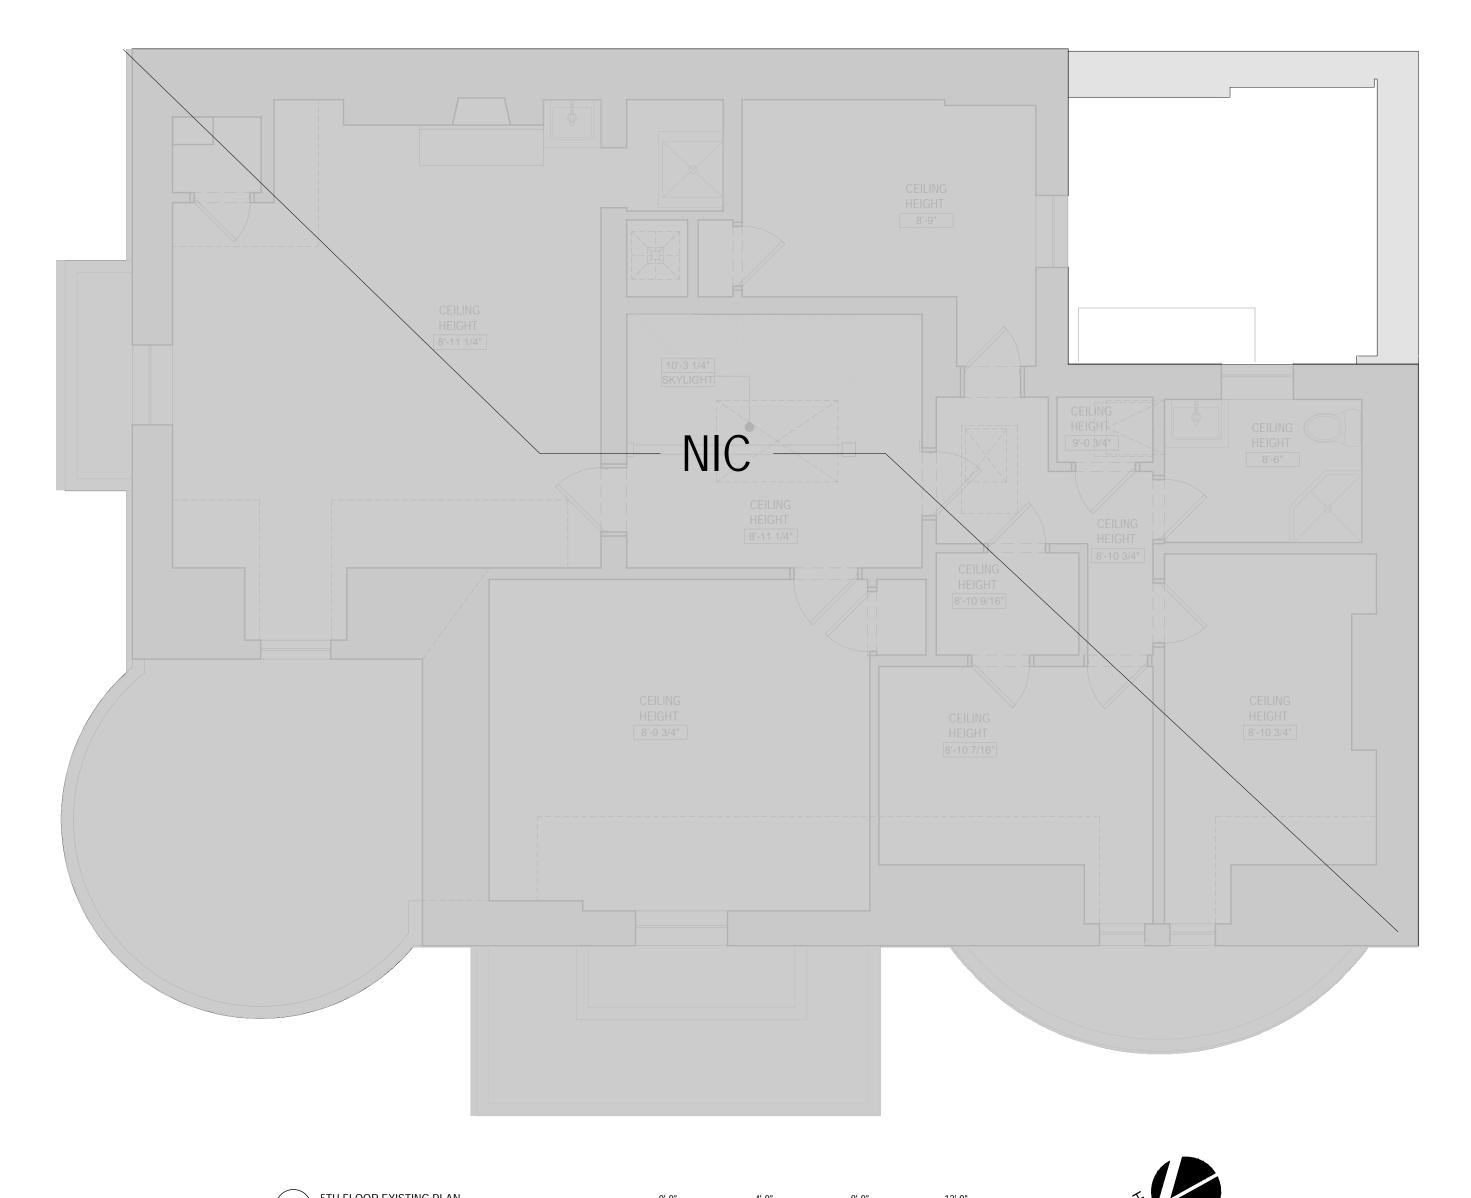
PROJECT NO.: 221163 DATE: 06.01.2021 DRAWN BY: MH CHECKED BY: SC/ML


> AREA: 9698 SQ FT # ISSUE DATE FOR LPC AND PERMIT 06/17/20 FOR LPC AND PERMIT FOR COMMUNITY BOARD HEARING 08/05/20

FOR COMMUNITY BOARD HEARING | 08/11/20 FOR LPC AND PERMIT SHEET TITLE

4TH FLOOR

CONSTRUCTION PLAN



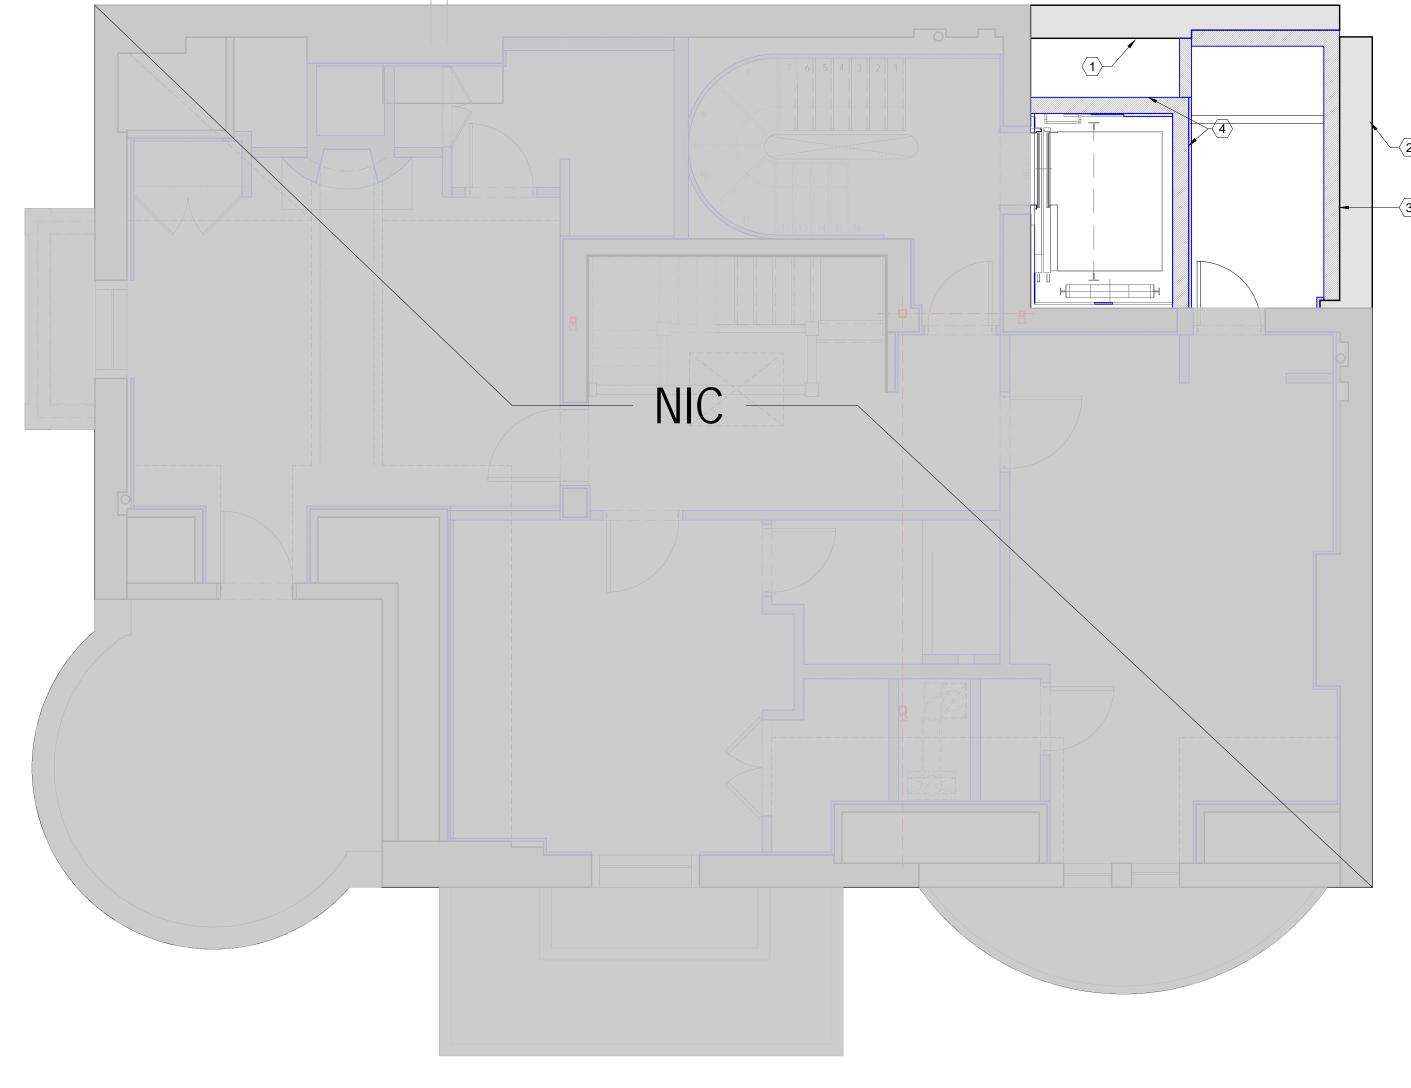

5TH FLOOR PROPOSED CONSTRUCTION PLAN

5TH FLOOR EXISTING PLAN

EXISTING PARTITION/ DEMISING WALL

NEW PARTITION - SEE PARTITION TYPES.

LINE OF SOFFIT ABOVE

CONSTRUCTION LEGEND:

ROOM NAME ROOM NAME

ROOM NUMBER

KEYNOTE

ELEVATION MARKER

- SHEET#

DOOR - SEE DOOR SCHEDULE

EXISTING WINDOW TO REMAIN

ELECTRICAL PANEL

EXISTING INTERCOM


POCKET DOOR - SEE DOOR SCHEDULE

EXISTING PARTITION TREATED WITH WATER

RESISTANT GWB & WATERPROOFING

(LATICRETE #9235 OR EQUAL)



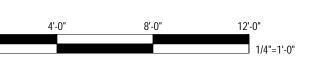

CONSTRUCTION NOTES ALL WORK SHALL CONFORM TO THE REQUIREMENTS OF THE NEW YORK CITY BUILDING CODE 1938 EDITION, FIRE DEPARTMENT REGULATIONS, UTILITY COMPANY REQUIREMENTS AND THE BEST

TRADE PRACTICES. BEFORE COMMENCING WORK, THE CONTRACTOR SHALL FILE ALL REQUIRED CERTIFICATES OF INSURANCE WITH THE DEPARTMENT OF BUILDINGS & OBTAIN ALL REQUIRED PERMITS. ALL INTERIOR DIMENSIONS ARE FROM FINISHED FACE U.O.N.

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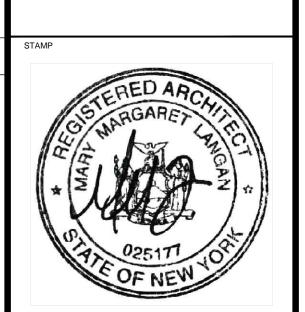
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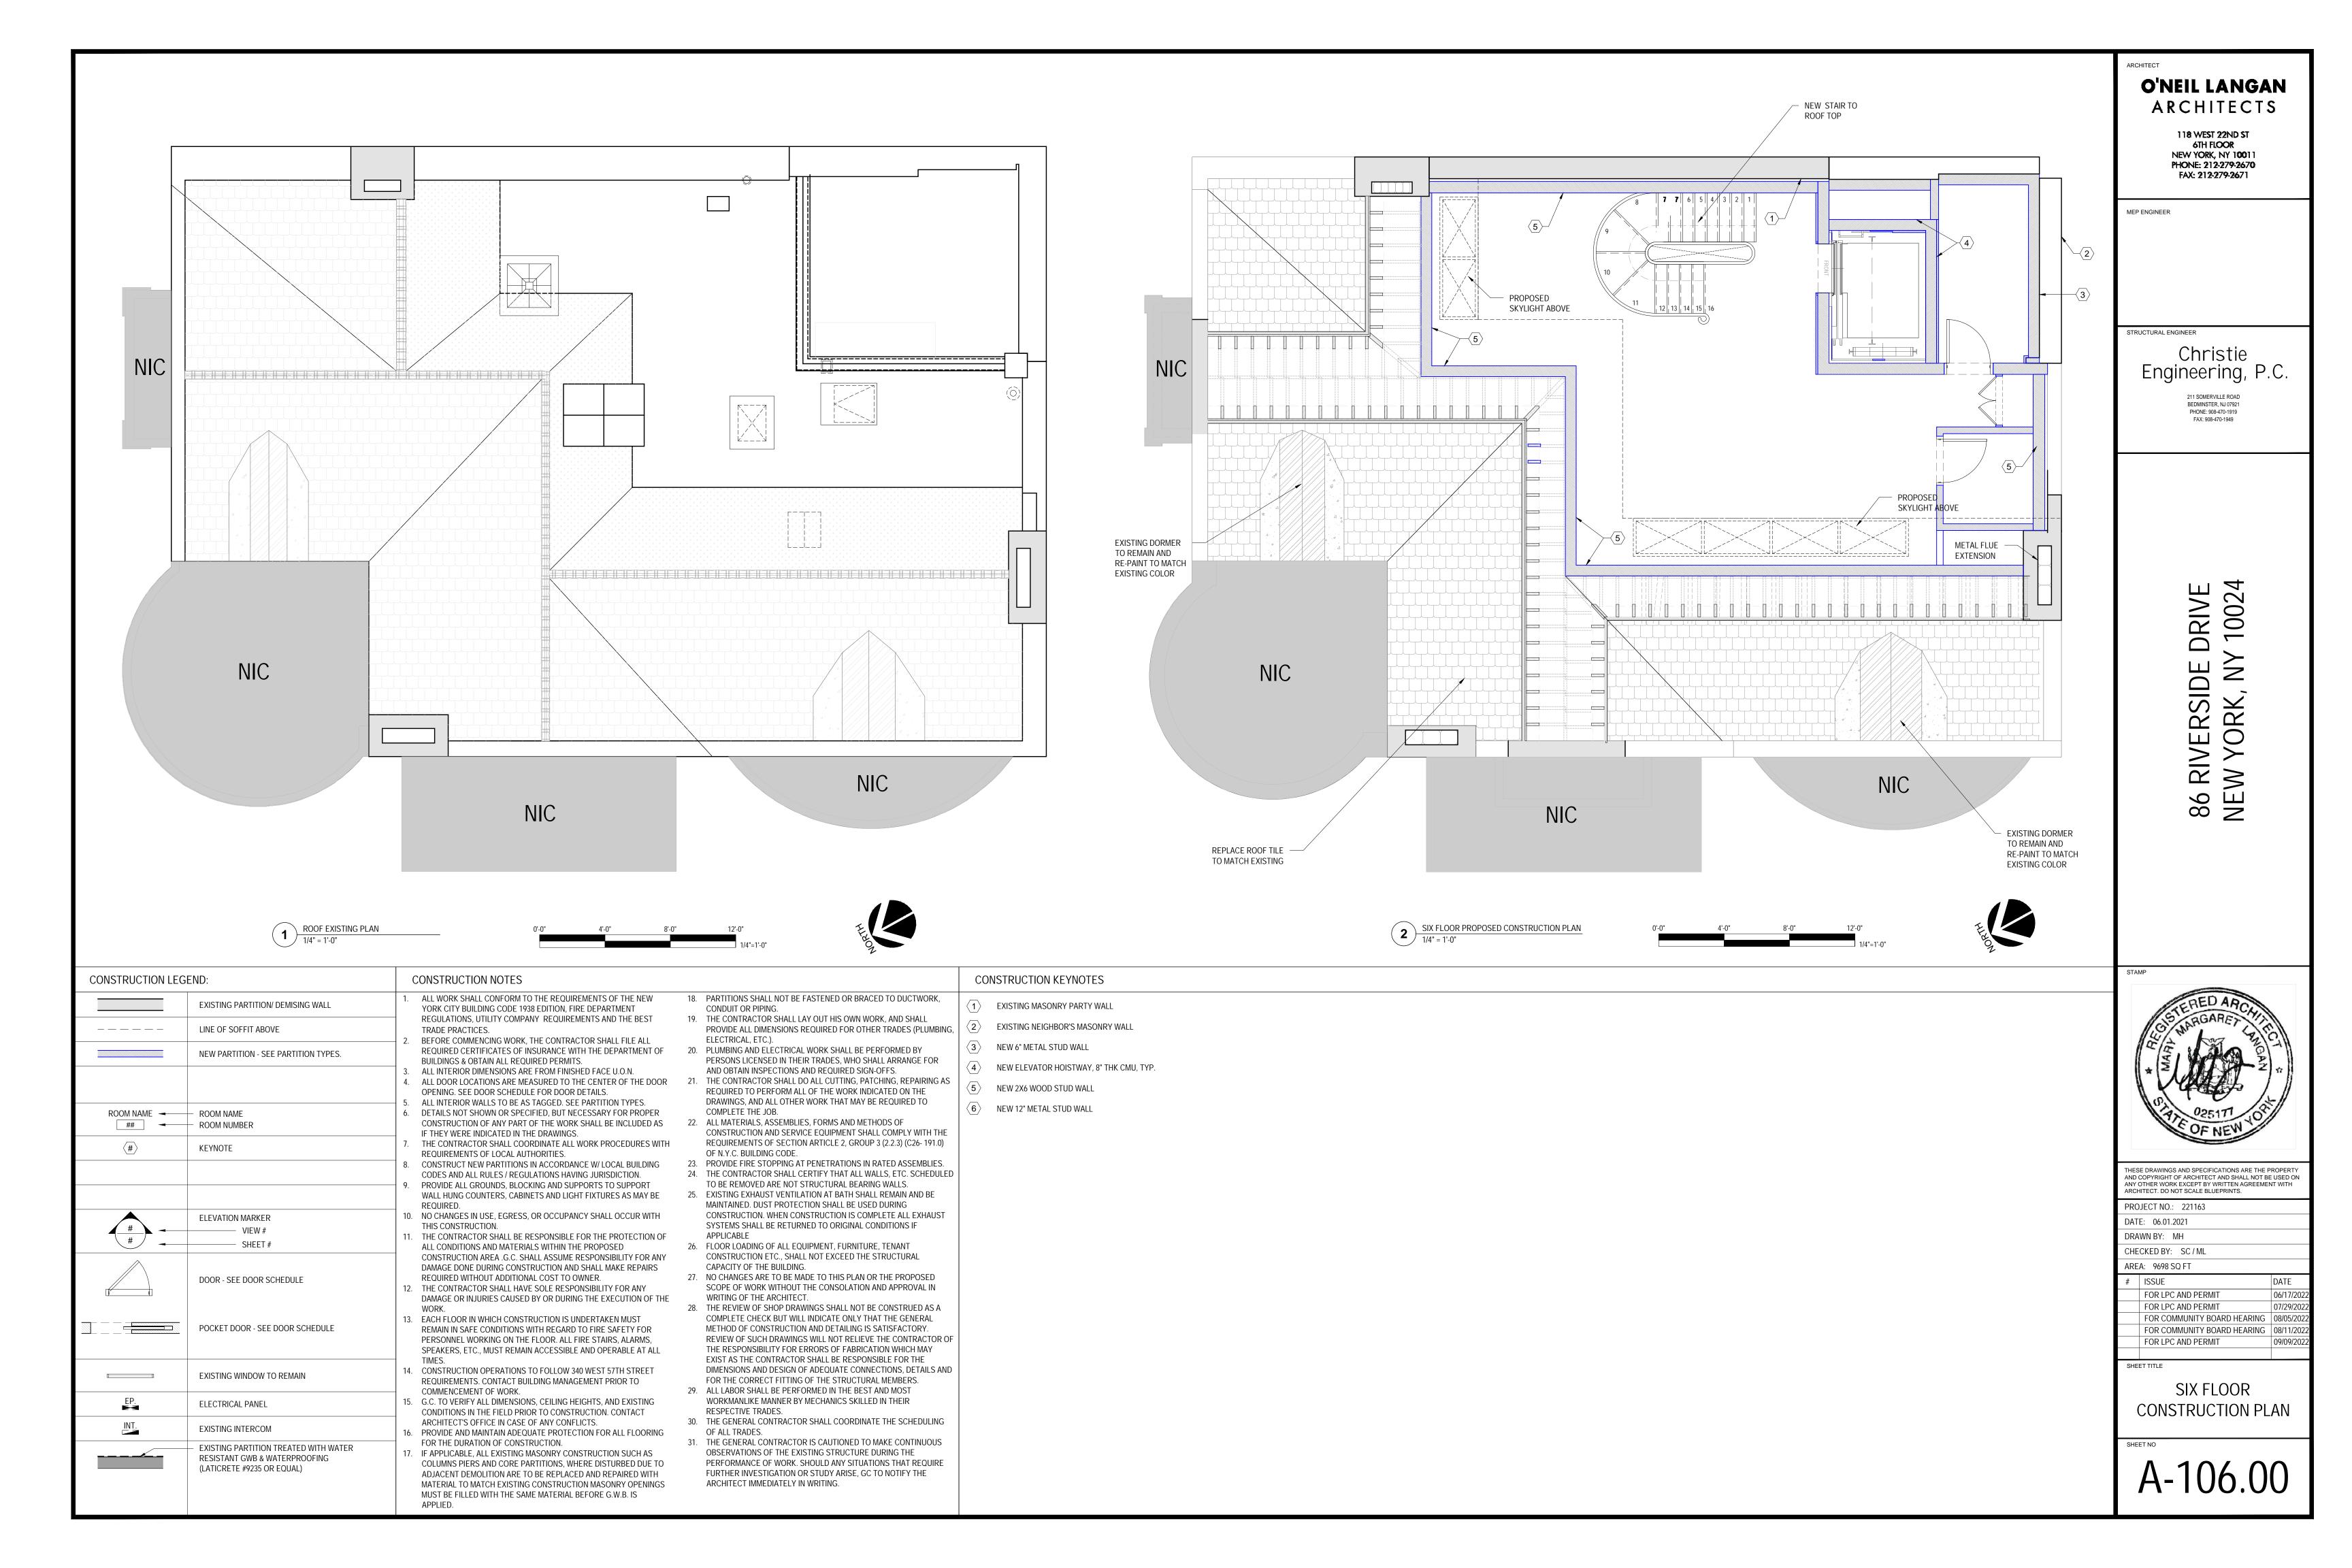
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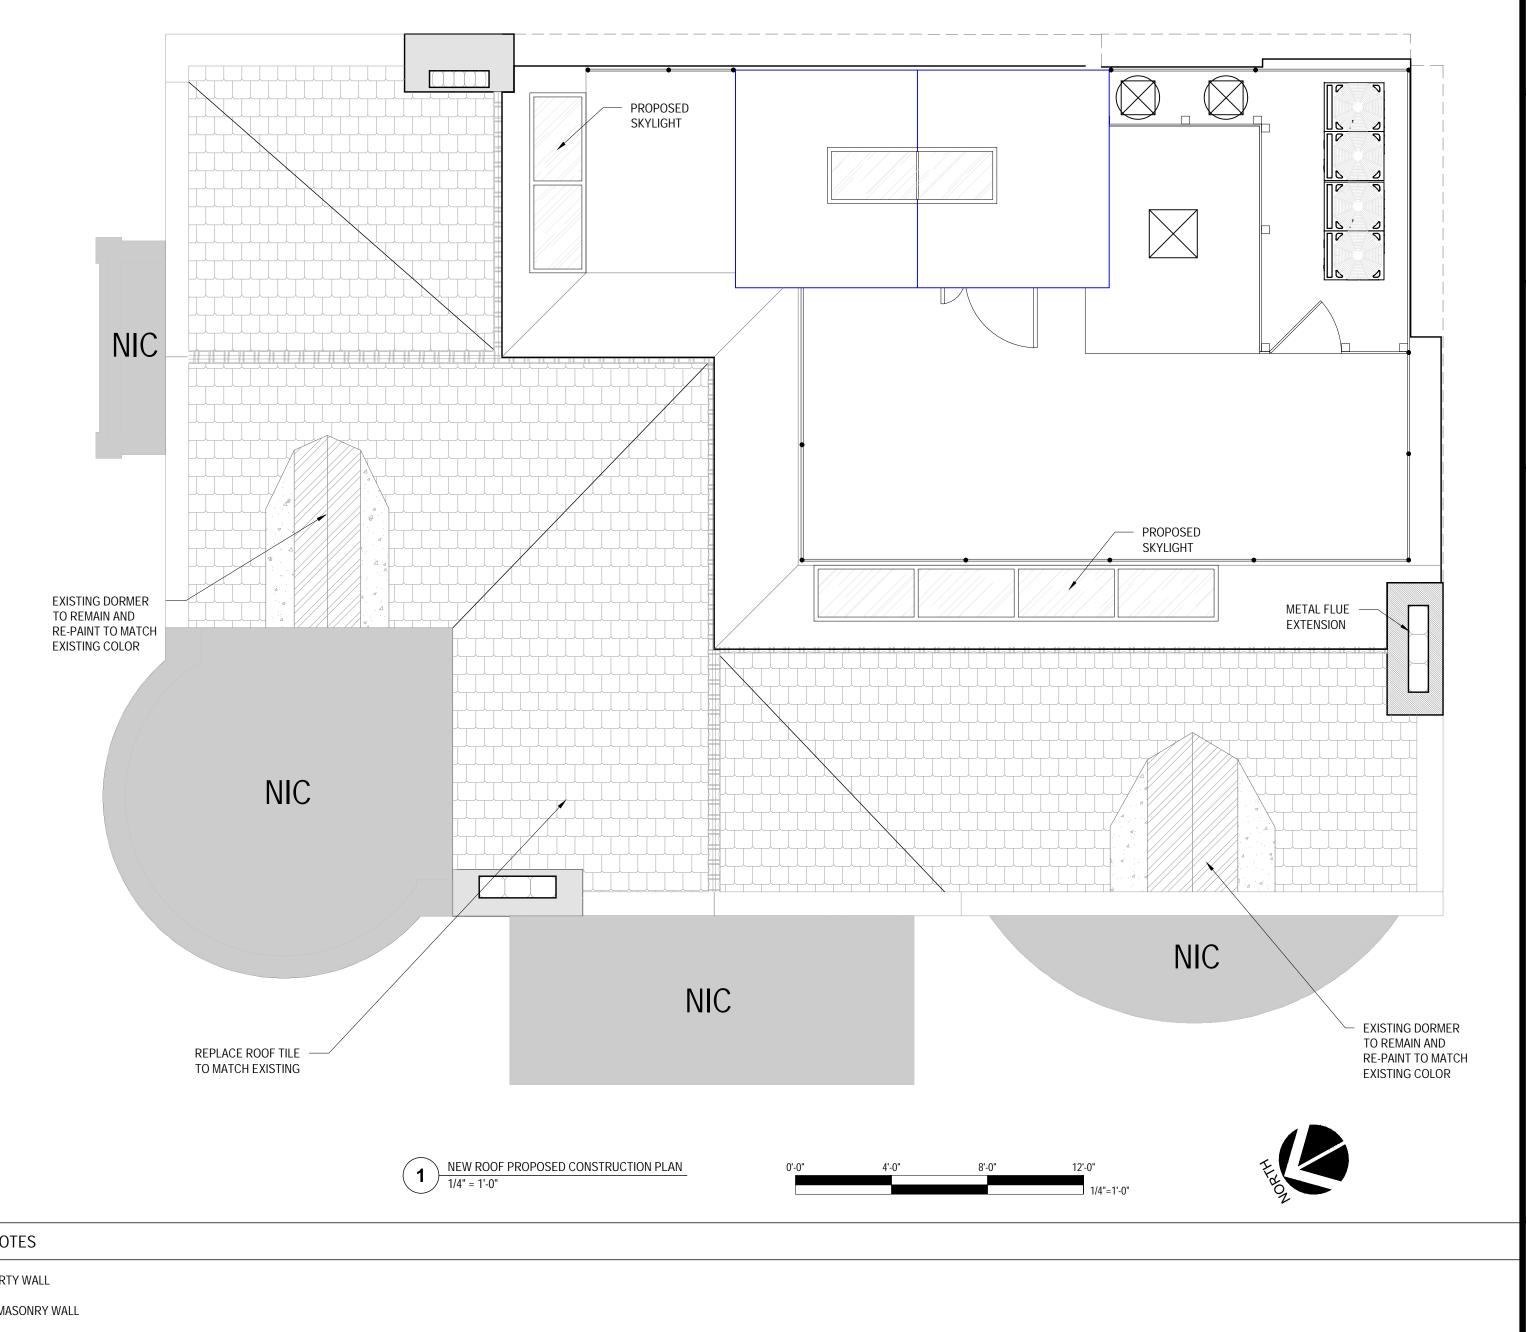
FOR LPC AND PERMIT 06/17/20 FOR LPC AND PERMIT FOR COMMUNITY BOARD HEARING 08/05/20 FOR COMMUNITY BOARD HEARING | 08/11/20 FOR LPC AND PERMIT

DATE

SHEET TITLE 5TH FLOOR

CONSTRUCTION PLAN





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YORK, NY

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STRUCTURAL ENGINEER

CONSTRUCTION LEGEND: CONSTRUCTION NOTES CONSTRUCTION KEYNOTES ALL WORK SHALL CONFORM TO THE REQUIREMENTS OF THE NEW 18. PARTITIONS SHALL NOT BE FASTENED OR BRACED TO DUCTWORK, EXISTING PARTITION/ DEMISING WALL (1) EXISTING MASONRY PARTY WALL CONDUIT OR PIPING. YORK CITY BUILDING CODE 1938 EDITION, FIRE DEPARTMENT REGULATIONS, UTILITY COMPANY REQUIREMENTS AND THE BEST 19. THE CONTRACTOR SHALL LAY OUT HIS OWN WORK, AND SHALL (2) EXISTING NEIGHBOR'S MASONRY WALL LINE OF SOFFIT ABOVE PROVIDE ALL DIMENSIONS REQUIRED FOR OTHER TRADES (PLUMBING, TRADE PRACTICES. BEFORE COMMENCING WORK, THE CONTRACTOR SHALL FILE ALL ELECTRICAL, ETC.) (3) NEW 6" METAL STUD WALL 20. PLUMBING AND ELECTRICAL WORK SHALL BE PERFORMED BY REQUIRED CERTIFICATES OF INSURANCE WITH THE DEPARTMENT OF NEW PARTITION - SEE PARTITION TYPES. PERSONS LICENSED IN THEIR TRADES, WHO SHALL ARRANGE FOR BUILDINGS & OBTAIN ALL REQUIRED PERMITS. $\langle 4 \rangle$ NEW ELEVATOR HOISTWAY, 8" THK CMU, TYP. 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